DOCKET NO. 20240023-WS FILED 1/23/2024 DOCUMENT NO. 00293-2024 FPSC - COMMISSION CLERK

BEFORE THE FLORIDA PUBLIC SERVICE COMMISSION

In re: Application for Certificates to provide Water and Wastewater service by North Lake County Water & Sewer Company LLC in Lake County Florida

Docket No.:

APPLICATION OF NORTH LAKE COUNTY WATER & SEWER COMPANY LLC FOR ORIGINAL WATER AND WASTEWATER CERTIFICATES AND APPROVAL OF INITIAL RATES AND CHARGES IN LAKE COUNTY

North Lake County Water & Sewer Company LLC (the "Utility"), by and through its undersigned attorneys and pursuant to Section 367.045, Florida Statutes, and Rule 25-30.033, Florida Administrative Code ("F.A.C."), hereby applies for original certificates to operate a water and wastewater system in Lake County, Florida, and for approval of initial rates, and charges. In support of its Application, the Utility submits the following information:

PART I: APPLICANT INFORMATION

A. The full name, mailing address, telephone number and Federal Employer Identification Number of the Utility are:

North Lake Water & Sewer Company LLC 8615 Commodity Cir., Suite 17 Orlando, FL 32819 FEI No. 86-3014998

B. The names, addresses, and phone numbers of the persons to contact concerning this Application are:

Martin S. Friedman
Dean, Mead, Egerton, Bloodworth, Capouano & Bozarth, P.A.
420 South Orange Ave.
Suite 700
Orlando, Florida 32801
mfriedman@deanmead.com

Direct: 407-310-2077

C. The Utility is a Florida limited liability company authorized to transact business in Florida on April 2, 2021, Document No. L21000154016. See **Exhibit** "I-C", attached.

D. The names, addresses and percentage ownership of each person that owns more than a five percent (5%) membership interest in the Utility are as follows:

Name <u>%</u>

Ownership

Sen Zhang 5410 Osprey Isle, Orlando, FL 32819 50%

Guan Rui Property Holdings LLC 16192 Coastal Highway, Lewes, DE 19958 24.5%

Yang Huang Property Holdings LLC 159 E. Huntington Dr., Ste. 10, Arcadia, CA 91006 25.5%

E. For Internal Revenue Code taxation purposes the Utility is a flow-through entity which does not pay taxes at the entity level.

F. The Application is for both water and wastewater certificates.

PART II: NEED FOR SERVICE

A. The property to be served by the Utility is a subdivision being developed as The Falls at Drake's Point ("Subdivision") by a party related to the Utility. Thus, there are no formal requests for service. The site plan is attached as **Exhibit "II-A".**

B. The Utility will serve 535 single family residential customers with 5/8' x 3/4' water meters, and general service connections consisting of a main clubhouse,

guardhouse, and a marina building, all of which will receive both water and wastewater service.

- C. To the best of the Utility's knowledge, the provision of the water and wastewater services are or will be consistent with the water and wastewater sections of the Lake County local comprehensive plan. The proposed service area's current land use designation is Planned Unit Development. See attached **Exhibit** "II-C".
- D. The proposed service area includes conservation lands and environmentally sensitive areas. Any impacts to these lands or areas, if proposed, will comply with applicable regulatory requirements, and have been addressed.

PART III: SYSTEM INFORMATION

- A. A description of the type and capacities of the water treatment plant, wastewater treatment is attached hereto as **Exhibit "III-A"**.
- B. The following is a description of the capacity of the wastewater treatment facility and method of effluent disposal.

The proposed capacity of the wastewater collection system will be designed and constructed to convey the maximum daily flow and the peak hour flow. This will be adequate to provide collection and treatment for the entire service area at build-out, which will have an annual average daily flow of 0.142 MGD. The WWTP will utilize Sequencing Batch Reactor Process with Class 1 component reliability. Effluent disposal via Dual Rapid infiltration Basins.

C. The Utility currently has no Florida Department of Environmental Protection wastewater operating permit since pursuant to Section 367.031, Florida Statutes, certificates from this Commission is a prerequisite to obtaining such permits. There is currently no Consumptive Use Permit for potable water use for the same reason, although there is a well for citrus/agricultural purposes.

D. Documentation of the Utility's ownership of the land upon which the utility treatment facilities are located is attached as **Exhibit "III-D"**.

E. The Utility will begin serving customers in the first quarter of 2025.

PART IV: FINANCIAL AND TECHNICAL INFORMATION

A. The Utility has the financial and technical ability to provide reasonably sufficient and efficient service. The Utility is an affiliated party of the Developer of the proposed service area and, as such, the Developer has provided the necessary start-up funding as well as funds sufficient to cover operational shortfalls during the Utility's initial years of operation. Attached as **Exhibit "IV-A"** is the operating statement and balance sheet. In addition, the Utility has retained the following professionals with regard to the engineering, design, permitting, construction, operation and regulation of its water and wastewater systems.

Wicks Engineering – Water & Sewer Engineers General Utilities Corporation – Operations RCM Utilities, LLC – Meter Reading & Billing Milian, Swain & Associates, Inc. – Regulatory Financial Dean Mead – Regulatory Legal

B. Applicant's rates for water and wastewater services have been structured to generate reasonable levels of revenue sufficient for it to achieve and sustain financial viability.

PART V: ACCOUNTING AND RATE INFORMATION

A report prepared by Milian, Swain & Associates, Inc. setting forth the required financial information for setting rates and charges is attached as **Exhibit** "V".

- A. Schedule 1 describes the projected rate base at 80% and 100% of design capacity including accumulated depreciation, projected CIAC and associated amortization, and working capital allowance.
- B. Schedules 1A and 1B show projected utility plant in service by NARUC accounts and related accumulated depreciation as of December 31, 2030 (at 100% of design capacity).
- C. Schedule 2, page 4, is the pro forma balance sheet projected as of December 31, 2030 (100% of capacity).
- D. Schedules 3A and 3B, provide the projected annual operating expenses by NARUC accounts at 80% of design capacity, projected at December 31, 2029.
- E. Schedules 4A & 4B, describe the Utility's proposed service availability charges were developed.
 - F. Schedule 6 miscellaneous service charges.
- G. Schedule 7 shows and proof of revenues and supporting schedules show how the proposed rates were developed.
- H. Schedule 8 shows the projected capital structure of the utility when the Utility reaches 80% capacity.
 - I. The supporting schedules are on pages 13-21.

PART VI: TERRITORY DESCRIPTION AND MAPS

A. TERRITORY DESCRIPTION

An accurate description of the water and wastewater utility service territory, using township, range and section references as specified in rule 25-30.030(2), F.A.C., is attached hereto as **Exhibit "VI-A"**.

B. TERRITORY MAPS

One copy of a map showing township, range and section with a scale such as 1"=200' or 1"=400' on which the proposed water and wastewater utility territory is plotted by use of metes and bounds or quarter sections and with a defined reference point of beginning is attached hereto as **Exhibit "VI-B"**.

C. SYSTEM MAPS

One copy of separate detailed map(s) showing proposed water and wastewater lines, facilities and the territory proposed are attached hereto as **Exhibit "VI-C"**.

PART VII: NOTICE OF APPLICATION

- A. Pursuant to Rule 25-30.030(4) F.A.C, a proposed Notice for Commission Staff approval is attached hereto as **Exhibit "VII"**. An affidavit that the notice of Application was given in accordance with Section 367.045(1)(a), Florida Statutes, and Rule 25-30.030, F.A.C., by regular mail to the following will be late-filed as **Exhibit "VII-A"**:
 - 1. the governing body of the municipality, county, or counties in which the system or the territory proposed to be served is located;
 - 2. the privately owned water and wastewater utilities that hold a certificate granted by the Public Service Commission and that are located within the county in which the utility or the territory proposed to be served is located;
 - 3. if any portion of the proposed territory is within one mile of a county boundary, the utility shall notice the privately owned utilities located in the bordering counties and holding a certificate granted by the Commission;
 - 4. the regional planning council;
 - 5. the Office of Public Counsel;
 - 6. the Public Service Commission's Director of the Division of the Commission Clerk and Administrative Services;

- 7. the appropriate regional office of the Department of Environmental Protection; and
- 8. the appropriate water management district.

B. An affidavit that the notice of actual Application was given in accordance with rule 25-30.030, F.A.C., by regular mail or personal delivery to each property owner in the proposed service area will be late-filed as **Exhibit "VI-B"**.

C. An affidavit that the notice of actual Application was published once in a newspaper of general circulation in the territory in accordance with rule 25-30.030, F.A.C. will be late-filed as **Exhibit "VI-C"**.

PART VIII: FILING FEE

The water system's proposed capacity will serve from 501 to 2,000 equivalent residential connections ("ERCs"), and the wastewater system's proposed capacity will serve from 501 to 2,000 ERCs; thus, the appropriate filing fee is \$3,000 (\$1,500 for the water system and \$1,500 for the wastewater system). A check for the filing fee in the amount of \$3,000 is being delivered by overnight delivery to the Commission Clerk on the date of this filing.

PART IX: TARIFFS

The water and wastewater tariffs containing all rates, classifications, charges, standard agreements, rules and regulations are attached hereto as Composite Exhibit "IX".

WHEREFORE, the Utility respectfully requests that the Commission grant:

(a) the original water and wastewater certificates to the Utility as requested herein;

- (b)approval of the Utility's initial rates, charges, standard service agreements and other tariff provisions as requested herein; and
- (c) such other relief as is fair, just and equitable.


Respectfully submitted this 23rd day of January, 2024.

Dean Mead 420 S. Orange Ave., Suite 700 Orlando, FL 32801 Telephone: (407) 310-2077 Fax: (407) 423-1831

mfriedman@deanmead.com

/s/Martin S. Friedman
MARTIN S. FRIEDMAN

Florida Department of State EXHIBIT I-C

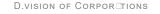



Department of State / Division of Corporations / Search Records / Search by Entity Name /

Detail by Entity Name

Florida Limited Liability Company NORTH LAKE COUNTY WATER & SEWER COMPANY LLC

Filing Information

Document Number L21000154016 **FEI/EIN Number** 86-3014998 **Date Filed** 04/02/2021

State FL

Status ACTIVE

Principal Address

8615 COMMODITY CIRCLE

STE 17

ORLANDO, FL 32819

Mailing Address

8615 COMMODITY CIRCLE

STE 17

ORLANDO, FL 32819

Registered Agent Name & Address

ZHANG, SEN

8615 COMMODITY CIR

STE 17

ORLANDO, FL 32819

Authorized Person(s) Detail

Name & Address

Title MGR

ZHANG, SEN 8615 COMMODITY CIR, STE 17 ORLANDO, FL 32819

Annual Reports

Report Year Filed Date 2022 04/21/2022 2023 01/26/2023


Document Images

 01/26/2023 -- ANNUAL REPORT
 View image in PDF format

 04/21/2022 -- ANNUAL REPORT
 View image in PDF format

 04/02/2021 -- Florida Limited Liability.
 View image in PDF format

Florida Department of State, Division of Corporations

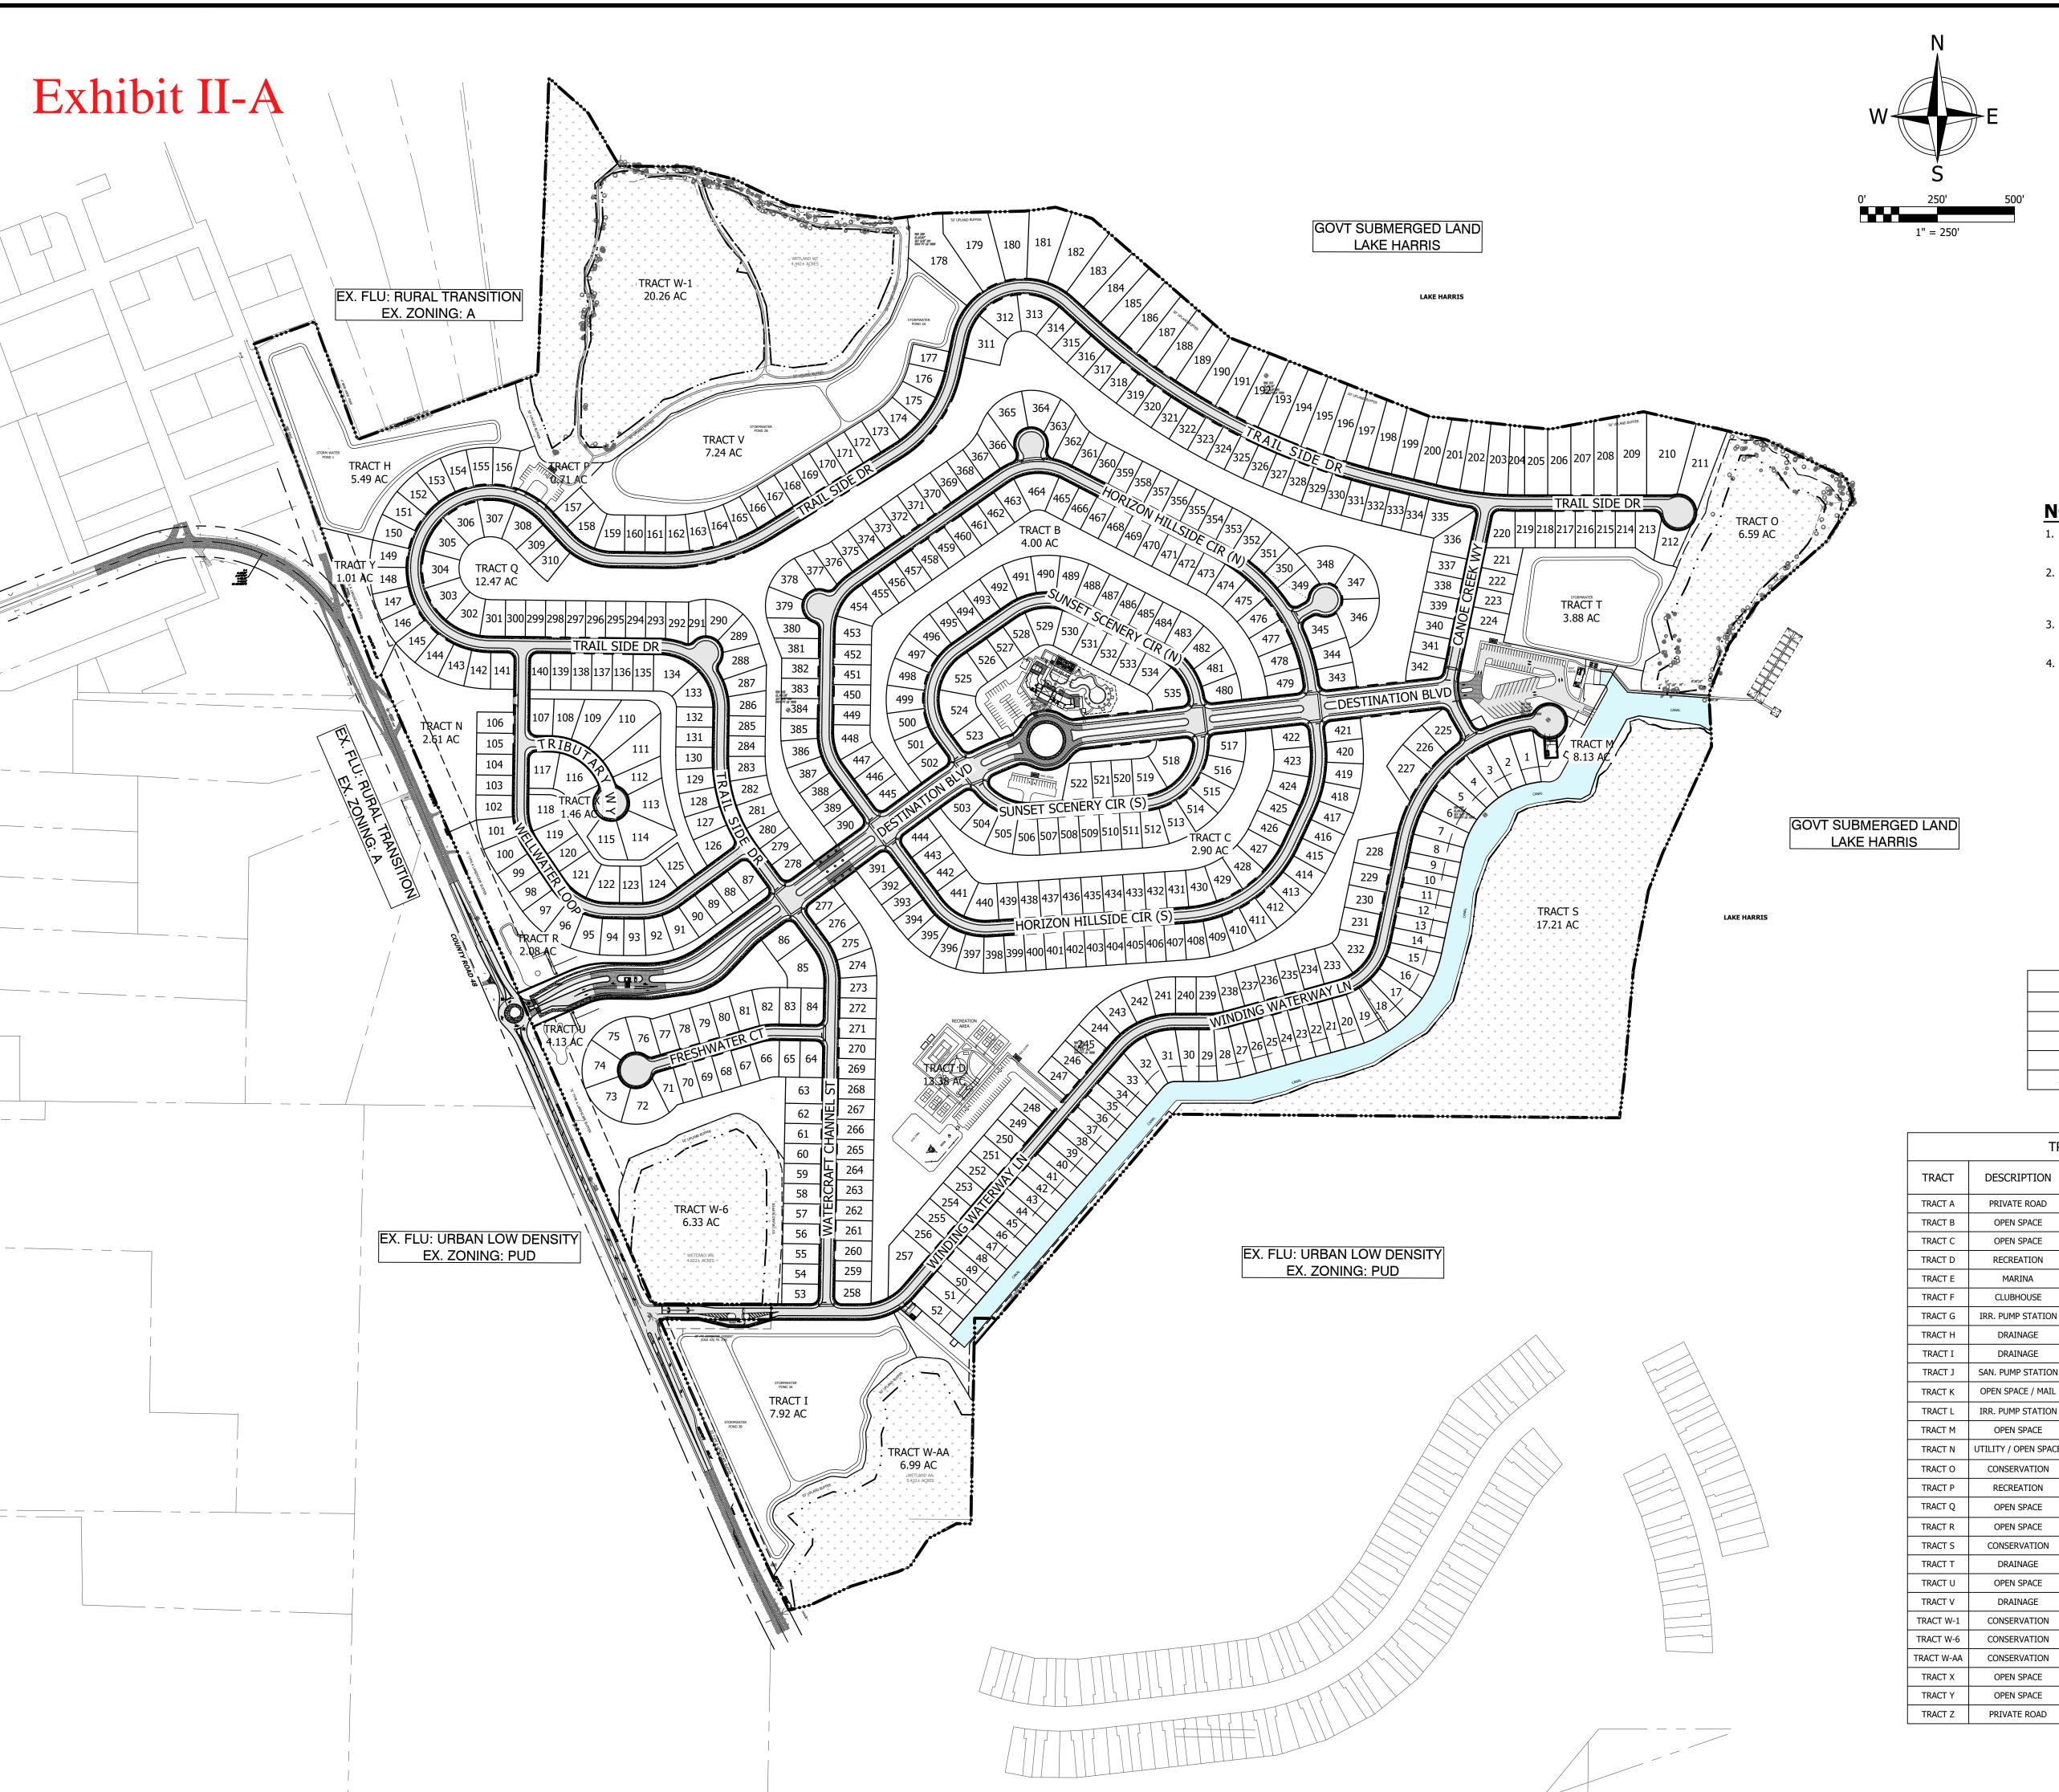

LEGEND

SITE BOUNDARY LINE CENTER LINE OF ROAD — — — RIGHT-OF-WAY LINE PROPOSED CURB

EXISTING EDGE OF PAVEMENT EXISTING PAVEMENT

EXISTING CONCRETE PAVEMENT

PROPOSED CONCRETE PAVEMENT PROPOSED ASPHALT PAVEMENT

TYPICAL HANDICAP SIDEWALK 5' RADIUS LINEAR FEET SQUARE FEET LOT GRADING TYPE


NOTES

- LEFT AND RIGHT TURN LANES WILL BE PROVIDED ON THE CONSTRUCTION PLANS.
- ALL INTERNAL SIDEWALKS WILL REQUIRE CURB RAMPS AT ALL INTERSECTIONS WITH CROSSWALKS. THESE WILL BE PROVIDED ON THE CONSTRUCTION PLANS.
- 3. ALL LOTS SHALL HAVE 5 FT MIN. DRAINAGE EASEMENTS ALONG THE REAR AND ALONG ALL INTERNAL LOT LINES. SEE SHEET 2.
- 4. THE CANAL SHALL BE MAINTAINED BY THE HOA.

LOT TABLE					
LOTS	TYPE				
1-52	50' WIDE				
53-187	65' WIDE				
188-221	75' WIDE				
222-550	65' WIDE				

TRACT SCHEDULE						
TRACT	DESCRIPTION	AREA (AC)	MAINTENANCE RESPONSIBILITY	OWNERSHIP		
TRACT A	PRIVATE ROAD	34.657	HOA	HOA		
TRACT B	OPEN SPACE	4.004	HOA	HOA		
TRACT C	OPEN SPACE	2.898	HOA	HOA		
TRACT D	RECREATION	13.375	HOA	HOA		
TRACT E	MARINA	2.393	HOA	HOA		
TRACT F	CLUBHOUSE	2.110	HOA	HOA		
TRACT G	IRR. PUMP STATION	0.049	HOA	HOA		
TRACT H	DRAINAGE	5.485	HOA	HOA		
TRACT I	DRAINAGE	7.922	HOA	HOA		
TRACT J	SAN. PUMP STATION	0.034	HOA	HOA		
TRACT K	OPEN SPACE / MAIL	0.867	HOA	HOA		
TRACT L	IRR. PUMP STATION	0.057	HOA	HOA		
TRACT M	OPEN SPACE	8.125	HOA	HOA		
TRACT N	UTILITY / OPEN SPACE	2.605	HOA	HOA		
TRACT O	CONSERVATION	6.592	HOA	HOA		
TRACT P	RECREATION	0.706	HOA	HOA		
TRACT Q	OPEN SPACE	12.472	HOA	HOA		
TRACT R	OPEN SPACE	2.079	HOA	HOA		
TRACT S	CONSERVATION	17.214	HOA	HOA		
TRACT T	DRAINAGE	3.879	HOA	HOA		
TRACT U	OPEN SPACE	4.129	HOA	HOA		
TRACT V	DRAINAGE	7.243	HOA	HOA		
TRACT W-1	CONSERVATION	20.262	HOA	HOA		
TRACT W-6	CONSERVATION	6.334	HOA	HOA		
TRACT W-AA	CONSERVATION	6.987	HOA	HOA		
TRACT X	OPEN SPACE	1.462	HOA	HOA		
TRACT Y	OPEN SPACE	1.007	HOA	HOA		
TRACT Z	PRIVATE ROAD	0.084	HOA	HOA		

&m>+&+Ozs

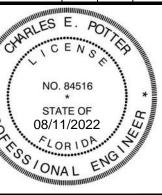

GPK HOLD

ORDINANCE 2022 - 49 1 FLU-21-05-3 2 **Drake Pointe PUD** 3 AN ORDINANCE OF THE BOARD OF COUNTY COMMISSIONERS OF LAKE COUNTY, FLORIDA; 4 5 AMENDING THE FUTURE LAND USE MAP FROM RURAL TRANSITION TO PLANNED UNIT 6 DEVELOPMENT FUTURE LAND USE CATEGORY FOR A 293.810 ACRE PROPERTY LOCATED 7 NORTHEAST OF COUNTY ROAD 48 AND ALONG LAKE HARRIS, IN THE HOWEY-IN-THE-HILLS AREA, AS DESCRIBED IN THIS ORDINANCE; AMENDING COMPREHENSIVE PLAN POLICY I-8 9 7.14.4 ENTITLED 'PLANNED UNIT DEVELOPMENT LAND USE CATEGORY' TO INCLUDE THE 10 DRAKE POINTE PLANNED UNIT DEVELOPMENT AND ASSOCIATED DEVELOPMENT PROGRAM 11 WHICH WILL ALLOW FOR THE DEVELOPMENT OF 535 DWELLING UNITS AND ASSOCIATED AMENITIES: PROVIDING FOR PUBLICATION AS REQUIRED BY SECTION 163.3184(11), FLORIDA 12 13 STATUTES; PROVIDING FOR SEVERABILITY; AND PROVIDING FOR AN EFFECTIVE DATE. 14 WHEREAS, Chapter 163, Florida Statutes, Part II, governs growth policy, county and municipal 15 planning, and land development regulation in the State of Florida; and 16 WHEREAS, Chapter 125, Florida Statutes, Section 125.01(1)(g), authorizes the Board of County 17 Commissioners of Lake County to "[p]repare and enforce comprehensive plans for the development of the 18 county"; and 19 WHEREAS, pursuant to Chapters 163 and 125, Florida Statutes, on the 25th day of May 2010, the Board of County Commissioners enacted Ordinance No. 2010-25, adopting the Lake County 2030 20 Comprehensive Plan; and 21 22 WHEREAS, on the 23rd day of July 2010, the State of Florida Department of Community Affairs, 23 now known as the Community Planning and Development Division of the Florida Department of Economic 24 Opportunity, published a Notice of Intent finding the Lake County 2030 Comprehensive Plan Amendment "In 25 Compliance" with Chapter 163, Florida Statutes; and 26 WHEREAS, on the 22nd day of September 2011, the Lake County 2030 Comprehensive Plan 27 became effective and designated the property as part of the Rural Transition Future Land Use Category; and 28 WHEREAS, Section 163.3184, Florida Statutes, sets forth the process for adoption of 29 Comprehensive Plan Amendments; and 30 WHEREAS, on the 1st day of June 2022, this Ordinance was heard at a public hearing before the 31 Lake County Planning & Zoning Board in its capacity as the Local Planning Agency; and 32 WHEREAS, on the 5th day of July 2022, this Ordinance was heard at a public hearing before the 33 Lake County Board of County Commissioners for approval to transmit to the state planning agency and other 34 reviewing agencies; and 35 WHEREAS, on the 1st day of November 2022, this Ordinance was heard at a public hearing before the Lake County Board of County Commissioners for adoption; and 36 37 WHEREAS, it serves the health, safety and general welfare of the residents of Lake County to adopt 38 the amendment to the Lake County Comprehensive Plan and Future Land Use Map. 39 NOW THEREFORE, BE IT ORDAINED by the Board of County Commissioners of Lake County,

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Florida, that:

 <u>Section 1. Comprehensive Plan Future Land Use Map Amendment.</u> The 2030 Comprehensive Plan Future Land Use Map is hereby amended to change the Future Land Use Category for the subject property, described in Exhibit "A" attached and incorporated in this Ordinance, from Rural Transition to Planned Unit Development Future Land Use Category.

<u>Section 2. Comprehensive Plan Text Amendment.</u> The Lake County 2030 Comprehensive Plan, Policy I-7.14.4 entitled 'Planned Unit Development Land Use Category,' shall be amended to read as follows:

Policy I-7.14.4 Planned Unit Development Land Use Category

The following land use table details the development program, including the maximum densities and intensities, for the adopted Planned Unit Development Future Land Use designations:

Amendment No.	Name / Location	Former FLU Designation	Development Program	Ordinance No.
FLU-19-02-4	Sorrento Pines	Rural Transition	Residential [328 dwelling units and 45% open space]	2019-72
FLU-19-07-2	Evergreen Estates	Residential [Two (2) dwelling units per net acre]; there shall be no access, emergency or otherwise, to Flynn Court or Champagne Drive except for the 5-acre estate lots		2020 - 65
FLU-21-01-1	Holiday Travel Park	Urban Low and Urban Medium	995 Temporary RV spaces, 112 mobile home sites and associated facilities	2021 – 38
FLU-21-03-5	Wildwoods Campground	Rural	84 RV spaces, Three (3) dwelling units and accessory uses	2021 - 40
FLU-21-08-5	Expert Investments	Rural Transition	10 dwelling units	2022 - 29
FLU-22-06-5	Illinois-Crown	Rural	Residential [2 single family dwelling units with accessory structures]	2022 - 32
FLU-21-05-3	<u>Drake Pointe</u>	Rural Transition	Residential [535 dwelling units and 46% open space] with associated amenities	<u>2022- XX</u>

<u>Section 3. Advertisement.</u> This Ordinance was advertised pursuant to Sections 125.66 and 163.3184, Florida Statutes.

<u>Section 4. Severability.</u> If any section, sentence, clause, phrase or word of this Ordinance is for any reason held or declared to be unconstitutional, inoperative or void, such holding or invalidity shall not affect the remaining portions of this Ordinance; and it shall be construed to have been the Commissioners' intent to pass this Ordinance without such unconstitutional, invalid or21-08-5 inoperative part therein; and the remainder of this Ordinance, after the exclusion of such part or parts shall be deemed and held to be valid, as if such parts had not been included herein; or if this Ordinance or any provisions thereof shall be held inapplicable to any person, groups of persons, property, kind of property, circumstances or set of circumstances, such holding shall not affect the applicability thereof to any other person, property or

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monast

Melanie Marsh, County Attorney

circumstances.

Section 5. Effective Date. The effective date of this plan amendment, if the amendment is not timely challenged, shall be 31 days after the state land planning agency notifies the local government that the plan amendment package is complete. If timely challenged, this amendment shall become effective on the date the state land planning agency or the Administration Commission enters a final order determining this adopted amendment to be in compliance. No development orders, development permits, or land uses dependent on this amendment may be issued or commence before it has become effective. If a final order of noncompliance is issued by the Administration Commission, this amendment may nevertheless be made effective by adoption of a resolution affirming its effective status, a copy of which resolution shall be sent to the state land planning agency.

11 12	ENACTED this <u>1st</u> day of <u>November</u> , 2022. FILED with the Secretary of State <u>November 2nd</u> , 2022.
13 14	FILED with the Secretary of State November 2nd, 2022.
15 16	
17	BOARD OF COUNTY COMMISSIONERS
18	LAKE COUNTY, FLORIDA
19 20	
21	Sum Marka
22	Sean M. Parks, Chairman
23 24	ATTEST:
25	
26	2 de la company
27 28	Gary J. Cooney, Clerk Board of County Commissioners of
29	Lake County, Florida
30	,
31	Approved as to form and logality:
32 33	Approved as to form and legality:
31	

Exhibit "A" – Legal Description

1 2 3

PROPERTY ALTERNATE KEY NUMBERS:

4 1226155, 3450221, 1242371, 3815464, 1371961, 3827817, 1517389, 3855902, 1535972, 3878118, 1673801, 1792304, 1792312, 3827816, 2923989, 2923962, 1792291, 3016050, 2704381, 1803411, 1803403

A PARCEL OF LAND LYING IN SECTION 15 AND 22, TOWNSHIP 20 SOUTH, RANGE 25 EAST BEING DESCRIBED AS FOLLOWS:

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COMMENCE AT NORTH QUARTER CORNER OF SAID SECTION 22 FOR A POINT OF REFERENCE: 10 THENCE RUN NORTH 89°14'57" WEST ALONG THE SOUTH LINE OF THAT CERTAIN QUIT CLAIM 11 12 DEED, RECORDED IN OFFICIAL RECORDS BOOK 5263, PAGE 681, OF THE PUBLIC RECORDS OF 13 LAKE COUNTY, FLORIDA, 670.22 FEET TO THE EASTERLY RIGHT-OF-WAY LINE OF COUNTY ROAD 14 48; THENCE RUN THE FOLLOWING 4 COURSES ALONG SAID EASTERLY RIGHT-OF-WAY LINE, NORTH 23°24'43" WEST, 11531.02 FEET; THENCE RUN SOUTH 66°37'55" WEST, 16.97 FEET; THENCE 15 16 RUN NORTH 20°18'28" WEST, 226.54 FEET; THENCE DEPARTING SAID EAST RIGHT-OF-WAY LINE 17 OF COUNTY ROAD 48, RUN THE FOLLOWING 3 COURSES ALONG THE EAST RIGHT-OF-WAY LINE OF LIME AVENUE: NORTH 20°34'23" WEST, 201.94 FEET; THENCE RUN NORTH 20°00'00" WEST, 18 19 317.00 FEET; THENCE RUN NORTH 19°50'21" WEST, 405.58 FEET TO THE NORTH LINE OF QUIT 20 CLAIM DEED RECORDED IN OFFICIAL RECORDS BOOK 4470, PAGE 2292 OF SAID PUBLIC 21 RECORDS; THENCE RUN NORTH 69°59'13" EAST, ALONG SAID NORTH LINE, 210.05 FEET TO THE 22 EAST LINE OF SAID QUIT CLAIM DEED; THENCE RUN SOUTH 19°51'32" EAST, ALONG SAID EAST 23 LINE, 406.34 FEET TO THE SOUTHWEST CORNER OF LOT 3, A.J. PHARES YALAHA SUBDIVISION AS 24 REFERENCED ON THE MAP OF DRAKE POINT PARK, ACCORDING TO THE PLAT THEREOF AS 25 RECORDED IN PLAT BOOK 1, PAGE 19 OF SAID PUBLIC RECORDS; THENCE RUN NORTH 70°07'30" EAST, ALONG THE SOUTH LINE OF SAID LOT 3, A DISTANCE OF 622.19 FEET TO 26 27 THE WEST LINE OF THE CERTAIN WARRANTY DEED RECORDED IN OFFICIAL RECORDS BOOK 4452, PAGE 673 OF SAID PUBLIC RECORDS; THENCE RUN NORTH 02°08'18" EAST, ALONG SAID 28 29 WEST LINE, 961.62 FEET TO A POINT ON THE 62.5 FOOT CONTOUR LINE, BEING THE FLORIDA DEPARTMENT OF ENVIRONMENTAL PROTECTION "SAFE UPLAND" LINE OF THE WATERS OF LAKE 30 HARRIS, THENCE RUN ALONG SAID "SAFE UPLAND" LINE CONTOUR BEING APPROXIMATED BY 31 THE FOLLOWING COURSES: SOUTH 48°13'31" EAST, 171.61 FEET, SOUTH 30°28'21" EAST, 198.50 32 214.54 FEET. SOUTH 75°33'09" EAST. 33 SOUTH 89°28'36" EAST. 163.02 SOUTH 64°37'20" EAST, 195.83 FEET, SOUTH 81°24'01" EAST, 185.82 FEET, SOUTH 83°21'55" EAST, 34 150.78 FEET, NORTH 82°35'47" EAST, 145.75 FEET, NORTH 88°37'02" EAST, 289.27 FEET, 35 36 NORTH 82°48'31" EAST, 99.43 FEET, SOUTH 72°51'05" EAST, 124.28 FEET, SOUTH 49°04'35" EAST, 589.31 FEET, SOUTH 68°28'09" EAST, 696.95 FEET, SOUTH 83°52'42" EAST, 390.31 FEET, 37 38 NORTH 79°30'03" EAST, 312.29 FEET, SOUTH 77°09'39" EAST, 405.31 FEET, SOUTH 64°24'04" EAST, 39 SOUTH 18°43'07" EAST. 72.17 FEET, SOUTH 32°23'54" WEST, 158.54 290.41. FEET. 40 SOUTH 47°59'25" WEST, 306.08 FEET, SOUTH 34°28'28" WEST, 160.69 SOUTH 22°19'42" WEST, 170.42 FEET, SOUTH 02°47'59" EAST, 173.67 FEET, SOUTH 24°39'51" WEST, 41 379.39 FEET, SOUTH 20°53'09" WEST, 129.67 FEET, SOUTH 10°47'41" WEST, 262.36 FEET, 42 43 SOUTH 04°51'48" WEST, 356.75 FEET, SOUTH 06°43'37" WEST, 125.96 FEET, POINT BEING 100.00 44 FEET EASTERLY OF THE NORTHEAST CORNER OF THE AFORESAID SECTION 22; THENCE RUN 45 NORTH 89°32'11" WEST, 100.00 FEET TO THE NORTHEAST CORNER OF THE AFORESAID SECTION

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31 32

33

22: THENCE RUN NORTH 89°32'11" WEST, ALONG THE NORTH LINE OF THE NORTHEAST QUARTER 1 2 OF SAID SECTION 22, A DISTANCE OF, 1350.44 FEET; THENCE DEPARTING SAID NORTH LINE, RUN 3 SOUTH 40°37'42" WEST, 872.91 FEET TO THE SOUTH LINE OF THE NORTHEAST QUARTER OF THE 4 NORTHWEST QUARTER OF THE NORTHEAST QUARTER OF SAID SECTION 22; THENCE RUN NORTH 89°23'03" WEST, ALONG SAID SOUTH LINE, 73.32 FEET TO THE NORTHEAST CORNER OF 5 THE SOUTHWEST QUARTER OF THE NORTHWEST QUARTER OF THE NORTHEAST QUARTER OF 6 SAID SECTION 22; THENCE RUN SOUTH 01°02'44" WEST, THE EAST LINE OF THE SOUTHWEST 7 8 QUARTER OF THE NORTHWEST QUARTER OF THE NORTHEAST QUARTER OF SAID SECTION 22, A 9 DISTANCE OF 666.91 FEET TO THE SOUTHEAST CORNER OF SOUTHWEST QUARTER OF THE 10 NORTHWEST QUARTER OF THE NORTHEAST QUARTER OF SAID SECTION 22; THENCE RUN NORTH 89°13'56" WEST ALONG THE SOUTH LINE OF SOUTHWEST QUARTER OF THE NORTHWEST 11 12 QUARTER OF THE NORTHEAST QUARTER OF SAID SECTION 22, A DISTANCE OF 47.47 FEET TO THE CENTERLINE OF A DITCH, THENCE RUN THE FOLLOWING 7 COURSES ALONG THE 13 14 CENTERLINE OF SAID DITCH: SOUTH 31°25'16" WEST, 1.75 FEET, SOUTH 62°36'34", 98.66', SOUTH 15 34°07'05" WEST, 113.15 FEET, SOUTH 67°31'03" WEST, 41.43 FEET, SOUTH 72°42'59" WEST, 159.42, 16 SOUTH 65°14'08" WEST, 143.37 FEET, SOUTH 76°24'55" WEST, 72.29 FEET TO A POINT ON THE 17 AFORESAID EAST RIGHT-OF-WAY OF COUNTY ROAD 48, SAID POINT IS LYING ON A NON-TANGENT 18 CURVE CONCAVE NORTHWESTERLY; THENCE RUN NORTHWESTERLY ALONG SAID NON-19 TANGENT CURVE HAVING A RADIUS OF 5679.57 FEET, A CENTRAL ANGLE OF 03°34'40", AN ARC 20 LENGTH OF 354.66 FEET, A CHORD LENGTH OF 354.60 FEET, AND A CHORD BEARING OF 21 NORTH 24°58'35" WEST TO A POINT; THENCE RUN NORTH 23°24'43" WEST, NON-TANGENT TO 22 SAID CURVE, 677.51 FEET TO THE NORTH LINE OF TRACT "E", A REPLAT OF DRAKE POINT PARK, 23 ACCORDING TO THE PLAT THEREOF AS RECORDED IN PLAT BOOK 10, PAGES 63A AND 63B OF 24 SAID PUBLIC RECORDS THENCE RUN SOUTH 89°52'25" EAST, ALONG SAID NORTH LINE, 360.53 25 FEET; THENCE DEPARTING SAID NORTH LINE, RUN NORTH 01°07'49" EAST, 49.93 FEET TO THE 26 SOUTH LINE OF TRACT "D", A REPLAT OF DRAKE POINT PARK, ACCORDING TO THE PLAT THEREOF 27 AS RECORDED IN PLAT BOOK 10, PAGES 63A AND 63B OF THE PUBLIC RECORDS; THENCE RUN 28 NORTH 89°51'45" WEST ALONG THE SOUTH LINE OF SAID TRACT "D", 383.19 FEET TO THE 29 AFORESAID EAST RIGHT-OF-WAY OF COUNTY ROAD 48; THENCE RUN NORTH 23°24'43" WEST, 30 691.61 FEET TO THE POINT OF BEGINNING.

THE ABOVE DESCRIBED PARCEL OF LAND LIES IN LAKE COUNTY, FLORIDA AND CONTAINS 293.810 ACRES MORE OR LESS.



RON DESANTIS
Governor

CORD BYRD Secretary of State

November 2, 2022

Honorable Gary J. Cooney Clerk of the Circuit Court and Comptroller Lake County 550 West Main Street P. O. Box 7800 Tavares, Florida 32778-7800

Attention: Josh Pearson

Dear Gary Cooney,

Pursuant to the provisions of Section 125.66, Florida Statutes, this will acknowledge receipt of your electronic copy of Lake County Ordinance No. 2022-49, which was filed in this office on November 2, 2022.

Sincerely,

Anya Owens Program Administrator

ACO/rra

PROPOSED PROJECT POTABLE WATER SUPPLY

The Drake Point project will require two (2) potable supply wells. The proposed location of these wells is near the center of the project and on one of the higher elevations on the site.

The proposed development of Drake Point will consist of 535 residential lots which equates to 535 ERCs. The additional facilities, clubhouse, etc., will also include some potable water demand. These are estimated at 12 ERCs, bringing the total to 547 ERCs. Based on an anticipated flow of 300 gpd per ERC the average daily flow for the project calculates at 154,500 gallons. Adding in a fire flow of 500 gpm for a one-hour period, the total flow would then be 184,500 +/- gallons for peak demand.

The design flow for the new wells will need to provide for the maximum hourly flow and will need to be rated between 500 and 600 gallons per minute. The actual sizing of the well/pump system will depend on the desired run time of each well/pump. At 600 gpm each well will run approximately 2.15 hours per day; at 500 gpm each will run 2.6 hours per day.

For this demand, the new wells will be 8" diameter, as a minimum, with 10" as a more likely design criterion, (One of the current irrigation wells may be able to be converted to a potable well and used as a standby or supplemental well. Further testing of this well is needed for both quality and quantity criteria before a decision can be made.)

PROPOSED WATER TREATMENT SYSTEM

As noted earlier, the average CUP daily flow for the project is approximately 154,500 gallons. With fire protection included, this will increase to approximately 184,500 gallons.

For a system this size and serving the number of connections, a complete system with standby power and redundant equipment is needed. A general summary of the required facilities is proposed as follows:

Ground Storage Tanks

The system will require two ground storage tanks each with a capacity of 100,000. These tanks will be approximately 40' in diameter and 15' in height. Dual tanks are required to maintain the system in operation during cleaning and/or maintenance of one of the tanks.

Pumps

To maintain the system in continued use, a pair of high service pumps will be necessary. These pumps will be equipped with Variable Frequency Drives and operate within the range of 300 to 500 gallons per minute as determined by pressure sensor located on the distribution line leaving the plant.

The treatment system will also require a set of small jockey pumps to maintain a minimum system pressure and keep the high services pump from running when the demand is very small. These pumps will be direct drive and operate for short duration to keep system pressure at a minimum.

The system will also require a fire pump to feed demand during a fire or extreme demand situations. This pump should be a direct drive pump rated somewhere between 750 and 1,000 gallons per minute.

Pump Building and Electrical

The pump location and electrical controls will be housed in a metal building that can also be used as office space and storage. It is anticipated that the building will be 40'x40' +/- and a portion of which will be air conditioned to keep the electrical panels from excessive heat buildup. Other options for the building could be block, wood or concrete panels, however, metal building seems to be the most flexible and least expensive.

Chlorination System

At this point, it appears that the treatment of the water will only require chlorination. This will be accomplished with liquid chlorine injection at each well. The detention time in the piping and storage tanks should be adequate to achieve the required treatment.

The system will also have a post chlorination system included. This will include a chlorine analyzer and injection point prior to the treated water leaving the plant site and connecting to the distribution system. The chlorine analyzer will relay data to a metered and proportional pump that will inject chlorine in the treated water, if necessary, to achieve the desired residuals.

Exhibit III-D

THIS INSTRUMENT PREPARED BY AND RETURN TO: Patricia R. Mueller, Esq.
PATRICIA R. MUELLER, P.A.
3900 Lake Center Drive, Suite A-5
Mount Dora, Florida 32757

INSTRUMENT #2021089842
OR BK 5741 PG 201 - 202 (2 PGS)
DATE: 6/30/2021 10:15:18 AM
GARY J. COONEY, CLERK OF THE CIRCUIT COURT
AND COMPTROLLER, LAKE COUNTY, FLORIDA
RECORDING FEES \$18.50 DEED DOC \$3850.00

Our File No.: 21-17

Property Appraisers Parcel Identification (Folio) Number: 1620250300-000-01000

Florida Documentary Stamps in the amount of \$3,850.00 have been paid hereon.

SPACE ABOVE THIS LINE FOR RECORDING DATA

WARRANTY DEED

THIS WARRANTY DEED, made the 24th day of June, 2021 by Larry Mott and Gwendolyn D. Mott, his wife, whose post office address is 8700 E. Treasure Island Avenue, Leesburg, FL 34788 herein called the Grantors, to North Lake County Water & Sewer Company LLC, a Florida limited liability company whose post office address is 8615 Commodity Circle, Ste 17, Orlando, FL 32819, hereinafter called the Grantee:

(Wherever used herein the terms "Grantor" and "Grantee" include all the parties to this instrument and the heirs, legal representatives and assigns of individuals, and the successors and assigns of corporations)

WITNESSETH: That the Grantors, for and in consideration of the sum of TEN AND 00/100'S (\$10.00) Dollars and other valuable considerations, receipt whereof is hereby acknowledged, hereby grants, bargains, sells, aliens, remises, releases, conveys and confirms unto the Grantee all that certain land situate in LAKE County, State of Florida, viz.:

Lots 17 and 18, and that part of Lots 10 through 14, lying South of Right of way of State Road 48, and that portion of a certain unnamed right of way, South of State Road No. 48 between Lots 13, 14, 17 and 18, Hutchinson's Addition to Yalaha, in Sections 15 and 16, Township 20, South, Range 25 East, Less that part of the West 25 feet of said lot 13 lying South of the Right of way of State Highway 48, and the West 25 feet of the North 103 feet of said Lot 18.

That portion of a certain unnamed right of way lying South of Lots 10 and 11, and North of Lots 14 and 15, Hutchinson's Addition to Yalaha, according to the plat thereof, in Sections 15 and 16, Township 20 South, Range 25 East, lying Easterly of Southeasterly right of way line of State Road No. 48.

Except the South 1/2 of the said right of way lying North of Lot 15.

The North 1/2 of Lot 16, Less the North 105 feet of the East 145 feet thereof, in Hutchinson's Addition to Yalaha, according to the plat thereof, in Sections 15 and 16, Township 20 South, Range 25 East, Lake County, Florida.

Subject to easements, restrictions and reservations of record and taxes for the year 2021 and thereafter.

TOGETHER, with all the tenements, hereditaments and appurtenances thereto belonging or in anywise appertaining.

TO HAVE AND TO HOLD, the same in fee simple forever.

AND, the Grantors hereby covenant with said Grantee that the Grantors are lawfully seized of said land in fee simple; that the Grantors have good right and lawful authority to sell and convey said land, and hereby warrant the title to said land and will defend the same against the lawful claims of all persons whomsoever; and that said land is free of all encumbrances, except taxes accruing subsequent to December 31, 2020.

File No.: 21-17

written. Signed, sealed and delivered in the presence of: Witness #1 Printed Name Witness #2 Signature Witness #2 Printed Name State of Florida **County of LAKE** The foregoing instrument was acknowledged before me by means of a physical presence or online notarization, this 24 day of Juhe, 2021, by Larry Mott and Gwendolyn D. Mott who are personally known to me or have as identification and \(\square\) did \(\square\) did not take an oath. SEAL Notary Public My commission expires: Printed Notary Name PATRICIA R. MUELLER Commission # GG 169135 Expires January 23, 2022

Bonded Thru Troy Fain Insurance 800-385-7019

IN WITNESS WHEREOF, the said Grantors have signed and sealed these presents the day and year first above

INSTRUMENT#: 2023058293 OR BK 6143 PG 1696 PAGES: 3 5/17/2023 11:34:29 AM GARY J. COONEY, CLERK OF THE CIRCUIT COURT & COMPTROLLER, LAKE COUNTY, FLORIDA

REC FEES: \$27.00 DEED DOC:\$1680.00

Prepared by and return to: Collin W. L. McLeod Attorney at Law Divine & Estes, P.A. 636 West Yale Street Orlando, FL 32804 407-426-9500 File Number: 3653-1

Special Warranty Deed

This Special Warranty Deed made this 15th day of May, 2023 between Robert Harmon and Betty Harmon, husband and wife, whose post office address is 5123 Puritan CR, Tampa, FL 33617, grantor, and North Lake County Water & Sewer Company LLC, a Florida limited liability company, whose post office address is 8615 Commodity Circle Suite 17, Orlando, FL 32819, grantee:

(Whenever used herein the terms grantor and grantee include all the parties to this instrument and the heirs, legal representatives, and assigns of individuals, and the successors and assigns of corporations, trusts and trustees)

Witnesseth, that said grantor, for and in consideration of the sum TEN AND NO/100 DOLLARS (\$10.00) and other good and valuable considerations to said grantor in hand paid by said grantee, the receipt whereof is hereby acknowledged, has granted, bargained, and sold to the said grantee, and grantee's heirs and assigns forever, the following described land, situate, lying and being in Lake County, Florida, to-wit:

BEG AT INTERSECTION OF S'LY R/W OF SR 48 & W LINE OF SEC 15-20-25, LAKE COUNTY, FLORIDA, RUN NE'LY & E'LY ALONG SAID S'LY R/W TO THE W'LY R/W LINE OF ORANGE AVE, AS PLATTED IN SUMTER COUNTY PLAT OF YALAHA, THEN RUN SE'LY ALONG SAID W'LY R/W OF ORANGE AVE TO THE N'LY R/W LINE OF GUAVA ST, AS PLATTED IN SUMTER COUNTY PLAT OF YALAHA, THENCE RUN SW ALONG SAID N'LY R/W LINE OF GUAVA ST TO W LINE OF SEC, RUN N'LY ALONG SAID W SEC LINE TO POB.

Parcel Identification Number: 15-20-25-0003-000-00700

Together with all the tenements, hereditaments and appurtenances thereto belonging or in anywise appertaining.

To Have and to Hold, the same in fee simple forever.

And the grantor hereby covenants with said grantee that the grantor is lawfully seized of said land in fee simple; that the grantor has good right and lawful authority to sell and convey said land; that the grantor hereby specially warrants the title to said land and will defend the same against the lawful claims of all persons claiming by, through or under grantors.

In Witness Whereof, grantor has hereunto set grantor's hand and seal the day and year first above written.

Signed, sealed and delivered in our presence:

Witness Name: A. A. Ford

Witness Tame: The Rhale

Cobert Harrison

Betty Harmon

State of Florida County of Lake

The foregoing instrument was acknowledged before me by means of [X] physical presence or [] online notarization, this day of May, 2023 by Robert Harmon and Betty Harmon, who [] are personally known or Rawe produced a driver's license as identification.

[Notary Seal]

RUTH FERNANDEZ
Notary Public-State of Florida
Commission # GG 933355
My Commission Expires
November 20, 2023

Notary Public

Printed Name:

Ruth Fernandez

My Commission Expires:

Special Warranty Deed - Page 2

EXHIBIT "A" EXCEPTIONS

- 1. The lien of all taxes or special assessments for the year 2023 and thereafter, which are not yet due and payable.
- 2. All matters contained on the Plat of MAP OF YALHALA, as recorded in Plat Book 1, Page 4, Public Records of Sumter County, now Lake County, Florida, as affected by Resolution vacating street and lots recorded in O.R. Book 1820, Page 942, Public Records of Lake County, Florida.
- 3. Private easement rights of other owners of the subdivision known as MAP OF YALHALA, as recorded in Plat Book 1, Page 4, Public Records of Sumter County, now Lake County, Florida, as affected by Resolution vacating street and lots recorded in O.R. Book 1820, Page 942, to the use of the vacated street.



NORTH LAKE COUNTY WATER & SEWER COMPANY LLC

Financial statements

For the period 11/1/2022-10/31/2023

Prepared by:

Grace Song, CPA

Robinson & Associates Group

100 Church Street, New York, NY 10007

Gracesong@robinsoncpas.com

1:07 PM 11/21/23

Accrual Basis

NORTH LAKE COUNTY WATER & SEWER COMPANY LLC Profit & Loss

November 2022 through October 2023

	Nov '22 - Oct 23
Ordinary Income/Expense	
Expense	
Business Licenses and Permits	139.00
Total Expense	139.00
Net Ordinary Income	-139.00
Net Income	-139.00

1:08 PM 11/21/23

Accrual Basis

NORTH LAKE COUNTY WATER & SEWER COMPANY LLC Balance Sheet

As of October 31, 2023

	Oct 31, 23
ASSETS Current Assets Checking/Savings	
Checking account	150,324.00
Total Checking/Savings	150,324.00
Total Current Assets	150,324.00
Fixed Assets Fixed Assets	851,676.00
Total Fixed Assets	851,676.00
TOTAL ASSETS	1,002,000.00
LIABILITIES & EQUITY Equity	
Paid in capital Net Income	1,002,139.00 -139.00
Total Equity	1,002,000.00
TOTAL LIABILITIES & EQUITY	1,002,000.00

North Lake County Water & Sewer Company LLC

Application for Original Certificate

Accounting Information

Docket No.

January 2024

North Lake County Water & Sewer Company LLC Initial Rates and Charges Docket No.:

Index

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Schedule 1
Docket No.:

North Lake County Water & Sewer Company LLC Initial Rates and Charges Projected Rate Base at 100% and 80% of Designed Capacity

Line		12/31/2030	12/31/2029	Referenced
No	Description	100%	80%	Schedule No.
1	Water Rate Base			
2				
3	Utility Plant in Service	\$ 7,022,287 \$	7,022,287	1 A
4	Accumulated Depreciation	(1,069,024)	(874,656)	1 A Support
5	Contributions in Aid of Construction	(3,611,203)	(3,431,203)	1 A Support
6	Accumulated Amortization of CIAC	436,982	343,815	1 A Support
7	Working Capital Allowance (1/8 O&M)	23,330	7,368	
8	Water Rate Base	\$ 2,802,372 \$	3,067,612	
9				
10				
11				
12	Wastewater Rate Base			
13				
14	Utility Plant in Service	\$ 7,195,776 \$	7,195,776	1 B
15	Accumulated Depreciation	(1,290,865)	(1,056,162)	1 B Support
16	Contributions in Aid of Construction	(4,397,925)	(4,127,925)	1 B Support
17	Accumulated Amortization of CIAC	600,888	466,762	1 B Support
18	Working Capital Allowance (1/8 O&M)	 17,696	7,368	
19	Wastewater Rate Base	\$ 2,125,570 \$	2,485,820	

North Lake County Water & Sewer Company LLC Initial Rates and Charges Pro Forma Water Utility Plant Projected December 31, 2030

Line	NARUC	ARUC Accumulated							
No.	Acct.	Description		Water	De	preciation	on Net Plant		
1	301	Organization	\$	10,200	\$	1,403	\$	8,798	
2	302	Franchises							
3	303	Land and Land Rights		425,000				425,000	
4	304	Structures and Improvements		2,117,138		363,883		1,753,255	
5	305	Collecting and Impounding Reservoirs							
6	306	Lake, River and Other Intakes							
7	307	Wells and Springs		718,750		131,771		586,979	
8	309	Supply Mains		192,325		30,223		162,103	
9	310	Power Generation Equipment							
10	311	Pumping Equipment							
11	320	Water Treatment Plant		718,750		179,688		539,063	
12	330	Distribution Reservoirs and Standpipes							
13	331	Transmission and Distribution Mains		2,626,624		335,964		2,290,660	
14	333	Services		-		-		-	
15	334	Meters and Meter Installation							
16	335	Hydrants		213,500		26,094		187,406	
17	339	Other Plant and Miscellaneous Equipment							
18	340	Office Furniture and Equipment							
19	341	Transportation Equipment							
20	343	Tools, Shop and Garage Equipment							
21	345	Power Operated Equipment							
22	346	Communication Equipment							
23	348	Other Tangible Plant							
24			\$	7,022,287	\$	1,069,024	\$	5,953,263	
25									
26		Treatment Capacity		0.184	mgo	t			
27		Line Capacity	535 ERCs						
28		ERC =	300 GPD						
29									
30 31	Notes:	(1) Water Treatment Plant Cost including overheads Water Use Permit		718,750					
32		Total	_	718,750					

North Lake County Water & Sewer Company LLC Initial Rates and Charges Pro Forma Wastewater Utility Plant Projected December 31, 2030

Line	NARUC				Ac	cumulated		
No.	Acct.	Description		Wastewater		epreciation		Net Plant
1	351	Organization	\$	10,200	\$	1,403	\$	8,798
2	352	Franchises						
3	353	Land and Land Rights		425,000				425,000
4	354	Structures and Improvements		2,251,513		386,979		1,864,535
5	360	Collecting Wastewater - Force		902,981		165,547		737,435
6	361	Collecting Wastewater - Gravity		1,990,481		243,281		1,747,200
7	362	Special Collecting Structures						
8	363	Services to Customers		-		-		-
9	364	Flow Measuring Devices						
10	365	Flor Measuring Installations						
11	370	Receiving Wells						
12	371	Pumping Equipment		71,875		21,962		49,913
13	380	Treatment and Disposal Equipment		1,500,000		458,333		1,041,667
14	381	Plant Sewers						
15	382	Outfall Wastewater Lines		43,725		13,360		30,365
16	389	Other Plant and Miscellaneous Equipment						
17	390	Office Furniture and Equipment						
18	391	Transportation Equipment						
19	393	Tools, Shop and Garage Equipment						
20	395	Power Operated Equipment						
21	398	Other Tangible Plant						
22			\$	7,195,776	\$	1,290,865	\$	5,904,911
23				·		·		
24		Treatment Capacity		0.142	mg	d		
25		Line Capacity (per factored ERCs)		535	ERC	Cs		
26		ERC =	250 GPD					

North Lake County Water & Sewer Company LLC Initial Rates and Charges Pro Forma Balance Sheet at 100% Design Projected December 31, 2030

Line	NARUC		
No.	Acct.	Assets and Other Debits	
1	101	Utility Plant In Service	\$ 14,218,063
2	103	Property Held For Future Use	
3	104	Utility Plant Purchased or Sold	
4	105	Construction Work in Progress	
5	108	Accumulated Depreciation and Amortization of UPIS	(2,359,889)
6	114	Utility Plant Acquisition Adjustments	
7	115	Accumulated Amortization of Utility Plant Acquisition Adjustments	
8	121	Nonutility Property	
9	122	Accumulated Depreciation and Amortization of Nonutility Property	
10	124	Utility Investments	
11	131	Cash	4,243
12	132	Special Deposits	
13	141	Customer Accounts Receivable	38,197
14	143	Accumulated Provision of Uncollectible Accounts - CR	
15	151	Plant Material and Supplies	
16	174	Miscellaneous Current and Accrued Assets	
17	186	Miscellaneous Deferred Debits	
18	190	Accumulated Deferred Income Taxes	
	190		
19		Total Assets and Other Debits	\$ 11,900,614
20			
21		Equity Capital	
22	201	Common Stock Issued	
23	204	Preferred Stock Issued	
24	211	Other Paid In Capital	4,459,564
25	215	Retained Earnings	457,047
26	218	Proprietary Capital	
27	224	Liabilities and Other Credits	
28	224	Long Term Debt	1 111
29 30	231 232	Accounts Payable	1,414
31	232	Notes Payable Customer Deposits	11,331
32	236	Accrued Taxes	11,551
33	237	Accrued Interest	
34	241	Miscellaneous Current and Accrued Liab.	
35	252	Advances for Construction	
36	253	Other Deferred Credits	
37	255	Accumulated Deferred Investment Tax Credits	
38	265	Accumulated Deferred Investment Tax Credits	
39	271	Contributions in Aid of Construction (CIAC)	8,009,128
40	272	Accumulated Amortization of CIAC	(1,037,870)
41	281	Accumulated Deferred Income Taxes -Accelerated Amortization	
42	282	Accumulated Deferred Income Taxes -Liberalized Depreciation	
43	283	Accumulated Deferred Income Taxes - Other	
44		Total Equity, Liabilities and Other Credits	\$ 11,900,614

North Lake County Water & Sewer Company LLC Initial Rates and Charges Water System

Pro Forma Expenses for Water Utility based on projections at 80% Design Capacity Projected December 31, 2029

Line	NARUC		
No.	Acct. No.	Description	Water
1	601	Salaries and Wages - Employees	
2	603	Salaries and Wages - Other	
3	604	Employees Pensions and Benefits	
4	610	Purchased Water	
5	615	Purchased Power	
6	616	Fuel for Power Production	
7	618	Chemicals	
8	620	Materials and Supplies	
9	630	Contract Services - Plant Operations	16,971
10	630	Contract Services - Billing	36,318
11	630	Contract Services - Engineering	2,829
12	630	Contract Services - Accounting	2,829
13	640	Rents	
14	650	Transportation Expense	
15	655	Insurance Expense	
16	665	Regulatory Commission Expense	
17	670	Bad Debt Expense	
18	675	Miscellaneous Expense	
19	403	Depreciation - Net of CIAC Amortization	107,104
20	407	Amortization Expense - Intangible	255
21	408	Taxes Other Than Income (1)	68,373
22		Total Expenses	234,678
23			
24		Average Cost per customer per month	\$ 34.49
25		Total	93,274
26	(1) Taxes oth	er than Income	
27		Property Taxes (net tangible plant X millage)	
28		(12.0498)	46,451
29		Regulatory Assessment Fees	21,921
30			

Schedule 3 B Docket No.:

North Lake County Water & Sewer Company LLC Initial Rates and Charges Wastewater System

Pro Forma Expenses for Wastewater Utility based on projections at 80% Design Capacity Projected December 31, 2029

Line NARUC Description No. Acct. No. Wastewater 1 701 Salaries and Wages - Employees 2 703 Salaries and Wages - Other 3 704 **Employees Pensions and Benefits** 4 **Purchased Wastewater Treatment** 710 5 711 Sludge Removal Expense 6 715 **Purchased Power** 716 **Fuel for Power Production** 8 718 Chemicals 9 720 Materials and Supplies 10 730 **Contract Services - Plant Operations** 16,971 36,318 11 730 Contract Services - Billing 12 730 Contract Services - Engineering 2,829 13 730 **Contract Services - Accounting** 2,829 14 740 750 15 Transportation Expense 16 755 Insurance Expense 17 765 **Regulatory Commission Expense** 18 770 **Bad Debt Expense** 775 19 Miscellaneous Expense 20 775 Miscellaneous Expense - Permit Fees 21 403 Depreciation - Net of CIAC Amortization 111,490 407 Amortization Expense - Intangible 22 255 23 408 Taxes Other Than Income (1) 52,497 24 Total Expenses 223,188 25 26 32.80 Average cost per customer per month 27 Total 94,806 28 (1) Taxes other than Income Property Taxes (net tangible plant X millage) 29 28 (12.0498)33,247 29 19,250 **Regulatory Assessment Fees** 30

Schedule 4A Docket No.:

North Lake County Water & Sewer Company LLC Initial Rates and Charges Service Availability Charge Analysis for Water Projected December 31, 2030

Line		2030
No.	Description	Water
1	Gross Book Value	\$ 7,022,287
2	Land	\$ 425,000
3	Depreciable Plant	\$ 6,597,287
4	Accumulated Depreciation to Date	\$ -
5	Accumulated Depreciation at Design Capacity	\$ 1,069,024
6	Net Plant at Design Capacity (includes land)	\$ 5,953,263
7	Transmission & Distribution / Collection Lines	\$ 2,840,124
8	Minimum Level of C.I.A.C.	40.44%
9	C.I.A.C. to Date	\$ 2,474,203
10	Accumulated Amortization of C.I.A.C. to Date	
11	Accumulated Amortization of C.I.A.C. at Design Capacity	\$ 315,410
12	Future Customers (ERC) to be Connected*	569
13	Composite Depreciation Rate	2.32%
14	Number of Years to Design Capacity	5.5
15	Existing Service Availability Charge Per ERC	\$ -
16	Level of C.I.A.C. at Design Capacity	0.00%
17	Requested Service Availability Charge Per ERC	\$ 2,000.00
18	Level of C.I.A.C. at Design Capacity	54.13%
19	Minimum Service Availability Charge Per ERC	\$ 468.00
20	Level of C.I.A.C. at Design Capacity	40.44%
21	Maximum Service Availability Charge Per ERC	\$ 4,337.00
22	Level of C.I.A.C. at Design Capacity	75.00%
23	Requested Service Availability Charge Per ERC	\$ 2,000.00
24	Requested Service Availability Charge Gallon Per Day	\$ 6.67
25		
26	Martin El Assortico	Requested
27	Main Extension	\$
28	Plant Capacity	\$ 2,000.00

Schedule 4B Docket No.:

North Lake County Water & Sewer Company LLC Initial Rates and Charges Service Availability Charge Analysis for Wastewater Projected December 31, 2030

Line			2030
No.	Description	1	Vastewater
1	Gross Book Value	\$	7,195,776
2	Land	\$	425,000
3	Depreciable Plant	\$	6,770,776
4	Accumulated Depreciation to Date	\$	-
5	Accumulated Depreciation at Design Capacity	\$	1,290,865
6	Net Plant at Design Capacity (includes land)	\$	5,904,911
7	Transmission & Distribution / Collection Lines	\$	2,893,463
8	Minimum Level of C.I.A.C.		40.21%
9	C.I.A.C. to Date	\$	2,692,425
10	Accumulated Amortization of C.I.A.C. to Date	\$	-
11	Accumulated Amortization of C.I.A.C. at Design Capacity	\$	380,422
12	Future Customers (ERC) to be Connected		569
13	Composite Depreciation Rate		2.57%
14	Number of Years to Design Capacity		5.5
15	Existing Service Availability Charge Per ERC	\$	-
16	Level of C.I.A.C. at Design Capacity		0.00%
17	Requested Service Availability Charge Per ERC	\$	3,000.00
18	Level of C.I.A.C. at Design Capacity		65.97%
19	Minimum Service Availability Charge Per ERC	\$	118.00
20	Level of C.I.A.C. at Design Capacity		40.21%
21	Maximum Service Availability Charge Per ERC	\$	4,011.00
22	Level of C.I.A.C. at Design Capacity		75.00%
23	Requested Service Availability Charge Per ERC	\$	3,000.00
24	Requested Service Availability Charge Gallon Per Day	\$	12.00
25			
26			Requested
27	Main Extension	\$	
28	Plant Capacity	<u>\$</u>	3,000.00

Schedule 5 Docket No.:

North Lake County Water & Sewer Company LLC Initial Rates and Charges Cost Justification for Service and Meter Installation Fees

Line No.	Description	Other <u>5/8 x 3/4" Sizes</u>
1	N/A Installed by builder	
2		
3		
4		
5		
6		
7		

Schedule 6
Docket No.:

North Lake County Water & Sewer Company LLC Initial Rates and Charges Cost Justification for Miscellaneous Service Charges Docket No.:

Line		Charge During Regular	Charge After Regular
No.	Description	Business Hours	Business Hours
1	Premise Visit Charge (1)	\$75.00	N/A
2			
3	Violation Disconnection	\$75.00	N/A
4			
5	Violation Reconnection	\$75.00	\$100.00
6			
7	Tampered Lock Fee	\$20.00	
8			
9	Water Meter Re-read Fee (1)	\$95.00	N/A
10			
11	Deposit for Temporary Meter	Actual Meter Cost	N/A
12			
13	Late Fee - First	\$10.00	
14			
15	Late Fee - Second	\$10.00	
16			
17	Returned Fee	per Florida Statute	
18			
19	Returned Fee - Electronic Item	\$30.00	
20			
21			
22	Notes:		
23	(1) Per contract with billing contractor		
24			

North Lake County Water & Sewer Company LLC Initial Rates and Charges Proof of Revenue Projected December 31, 2029

Rates	for
nates	101

Line			ates ioi			Dow.	anua Baguirad
No			evenue quirement	Total ERCs	Total Gallons		enue Required nual Revenue
1	Revenue Proof For Water		i din cinicino	Total Lives	Total Gallons		Tadi Neveride
2	Requested Rates - Residential - Monthly						
3	Base Facility Charge	\$	43.82	5,136		\$	225,056.44
4	Gallonage Charge	*		3,233		Ψ	223,030
5	First 7,000 gls	\$	4.59		39,367	Ś	180,852.84
6	Over 7,000 gls	\$	5.74		7,499		43,060.20
7	Total Residential Revenues	·			,	\$	448,969.48
8	Average Residential Bill					\$	87.42
9						<u> </u>	
10	Requested Rates - General Service						
11	5/8" x 3/4"	\$	43.82	0		\$	-
12	3/4"	*	65.73	0		Ψ	_
13	1"		109.55	0			-
14	1-1/2"		219.10	0			-
15	2"		350.56	24			8,413.44
16	- 3"		766.85	12			9,202.20
17	Charge per 1,000 gallons	\$	4.77		3,796	Ś	18,106.92
18	Total General Service Revenues	·			,	\$	35,722.56
19	Average General Service Bill					\$	992.29
20						<u> </u>	
21	Revenues from Miscellaneous Charges	\$	37.50	90		\$	3,375.00
22	Revenues from Wiscenarieous charges	Ψ.	37.30	50		7	3,373.00
23	Total Water Revenue at 100% Design Capacity					\$	488,067.04
24	, , , , , , , , , , , , , , , , , , ,					<u> </u>	
25	Revenue Proof For Wastewater						
26	Requested Rates - Residential - Monthly						
27	Base Facility Charge	\$	38.44	5,136		\$	197,435.47
28	Gallonage Charge (maximum 10,000 gls)	\$	4.91	5,255	39,055		191,760.05
29	Total Residential Revenues	·			,	\$	389,195.52
30	Average Residential Bill					\$	75.78
31						<u> </u>	
32	Requested Rates - General Service						
33	5/8" x 3/4"	\$	38.44	0		\$	_
34	3/4"	*	57.66	0		7	_
35	1"		96.10	0			_
36	1-1/2"		192.21	0			_
37	2"		307.53	24			7,380.72
38	3"		672.73	12			8,072.76
39	Charge per 1,000 gallons	\$	5.89		3,504	Ś	20,638.56
40	Total General Service Revenues	•			2,22	\$	36,092.04
41	Average General Service Bill					\$	1,002.56
42						т	1,002.30
43	Revenues from Miscellaneous Charges	\$	37.50	90		\$	3,375.00
44	Mevendes from Miscellaneous Charges	Y	37.30	50		¥	3,373.00
45	Total Wastewater Revenue at 100% Design Cap	acitv				\$	428,662.56
.5	- State Transfer Televisia at 200% Design Cup						,,,,,,,

North Lake County Water & Sewer Company LLC Initial Rates and Charges Projected Capital Structure When Utility Reaches 80% Capacity

Interim [] Final [x] Historical [x] Projected []

Explanation: Provide a schedule which calculates the requested cost of capital on a 13-month average basis. If a year-end basis is used, submit an additional schedule reflecting year-end calculations.

	(1)	(2) Reconciled to Rate Base (Schedule 1)		(3)		(4)		(5)
Line No.	Class of Capital	12/31/2029 - 80%	R	atio	C	Cost Rate	Wei	ghted Cost
1	Long Term Debt	\$ -						
2	Short Term Debt							
3	Preferred Stock							
4	Common Equity (1)	5,281,481		95.10%		8.54%		8.13%
5	Customer Deposits (2)	271,950		4.90%		2.00%		0.10%
6	Tax Credits - Zero Cost							
7	Tax Credits - Weighted Cost							
8	Accumulated Deferred Income Tax							
9	Other (Explain)							
10								
11	Total	\$ 5,553,431		100.00%				8.23%
12							·	
13	Note: The cost of equity is based on the lo	everage formula in effect pu	rsuant to	Order No. P	SC-2023	3-0189-PAA-WS		
14								
15								
16						General		
17	Outstanding Customer Deposit Balance	<u>e</u>	Resi	dential		Service		
18	New Customers connected 2028-29			180		34		
19	Deposit (2 x average monthly bill)		\$	450	\$	5,700		
20								
21	Deposit balance 12/31/2026 from nev	v customers	\$	81,000	\$	190,950	\$	271,950

				Annual	Plant Additions			
Туре	2024	2025	2026	2027	2028	2029	2030	TOTAL
ERCs	0	85	175	265	355	445	535	
331 T & D		\$2,626,624						\$2,626,624
333 Services								
335 Hydrants		\$213,500						\$213,500
WTP								
304 Structures		\$2,117,138						\$2,117,138
307 Wells		\$718,750						\$718,750
320 Wtr Treatment Equip		\$718,750						\$718,750
309 Supply Mains		\$192,325						\$192,325
Organization Cost (2023-2024)								
Milian, Swain & Associates	4,000							
Friedman & Friedman	4,000							
Internal costs	1,000							
Filing Fee	1,000							
Expense	200							
Total organizatio Cost	\$10,200	\$0	\$0	\$0	\$0		\$0	\$10,200
TOTAL	\$10,200	\$6,587,087	\$0	\$0	\$0	\$0	\$0	\$6,597,287
	\$10,200	\$6,597,287	\$6,597,287	\$6,597,287	\$6,597,287	\$6,597,287	\$6,597,287	

Fee - Plant			\$ 2,000.00	Schedule 4					
Fee - T&D			\$ -	Schedule 4					
Total T&D cost			2,840,124	Schedule 1B					
Total Factored ERCs			569	Capacity					
	2024	2024	2025	2026	2027	2028	2029	2030	TOTAL
Factored ERCs		0	119	90	90	90	90	90	569
Annual CIAC - Plant		\$0	\$237,000	\$180,000	\$180,000	\$180,000	\$180,000	\$180,000	\$1,137,000
Annual CIAC - T&D		\$0	\$2,474,203	\$0	\$0	\$0	\$0	\$0	\$2,474,203
TOTAL		\$0	\$2,711,203	\$180,000	\$180,000	\$180,000	\$180,000	\$180,000	\$3,611,20

Schedule 1A support Page 2 of 3 Docket No.:

	Depreciation	Depreciation Annual additions - AD														
Гуре	Life	2024		2025	2026	20	2027		28	2026	2	030				
ERCs																
331 T & D	43		\$	61,084	\$ -	\$	-	\$	-	\$	- \$					
333 Services	40		\$	-	\$ -	\$	-	\$	-	\$	- \$					
335 Hydrants	45		\$	4,744	\$ -	\$	-	\$		\$	- \$					
WTP																
304 Structures	32		\$	66,161	\$ -	\$	-	\$	-	\$	- \$					
307 Wells	30		\$	23,958	\$ -	\$	-	\$	-	\$	- \$					
320 Wtr Treatment Equip	22		\$	32,670	\$ -	\$	-	\$	-	\$	- \$					
309 Supply Mains	35		\$	5,495	\$ -	\$	-	\$		\$	- \$					
									·							
Total organizatio Cost	40		\$	255	\$ -	\$	-	\$	-	\$	- \$					

	PLANT		T&D	Total
Total Exp	\$ 128,539	\$ 6	5,829	\$ 194,368
Total Plant	\$3,757,163	\$2,84	0,124	\$6,597,287
%	3.42%		2.32%	2.95%
Years	29.23		43.14	33.94

CIAC Table	Amortization	Annual additions - Accum Amort												
Year	Life	2024	2025		2026		2027		2028		2029		2030	
Annual CIAC - Plant	29	\$ -	\$	8,108	\$	6,158	\$	6,158	\$	6,158	\$	6,158	\$	6,158
Annual CIAC - T&D	43		\$	57,347	\$	1	\$	1	\$	-	\$	-	\$	-
				\$65,456		\$6,158		\$6,158		\$6,158		\$6,158		\$6,158

					Accur	nula	ted Depre	iati	on				
Туре	2024		2025		2026		2027		2028		2029		2030
ERCs		-										_	
331 T & D		\$	30,542	\$	91,626	\$	152,711	\$	213,795	\$	274,879	\$	335,964
333 Services		\$	-	\$	-	\$	-	\$	-	\$	-	\$	-
335 Hydrants WTP		\$ \$	2,372	\$ \$	7,117	\$ \$	11,861	\$ \$	16,606	\$ \$	21,350	\$ \$	26,094
304 Structures		\$	33,080	\$	99,241	\$	165,401	\$	231,562	\$	297,723	_	363,883
307 Wells		\$	11,979	\$	35,938	\$	59,896	\$	83,854	\$	107,813	\$	131,771
320 Wtr Treatment Equip		\$	16,335	\$	49,006	\$	81,676	\$	114,347	\$	147,017	\$	179,688
309 Supply Mains		\$	2,748	\$	8,243	\$	13,738	\$	19,233	\$	24,728	\$	30,223
Total organizatio Cost		\$	128	\$	383	\$	638	\$	893	\$	1,148	\$	1,403
TOTAL			97,184	5	\$291,552	\$	485,920	5	680,288		\$874,656	\$1	1,069,024

				Dep	orec	iation Expe	ense					
2024		2025		2026		2027		2028		2029		2030
	\$	30,542	\$	61,084	\$	61,084	\$	61,084	\$	61,084	\$	61,084
	\$	-	\$	-	\$	-	\$	-	\$	-	\$	-
	\$	2,372	\$	4,744	\$	4,744	\$	4,744	\$	4,744	\$	4,744
	\$	-	\$	-	\$	-	\$	-	\$	-	\$	-
	\$	33,080	\$	66,161	\$	66,161	\$	66,161	\$	66,161	\$	66,161
	\$	11,979	\$	23,958	\$	23,958	\$	23,958	\$	23,958	\$	23,958
	\$	16,335	\$	32,670	\$	32,670	\$	32,670	\$	32,670	\$	32,670
	\$	2,748	\$	5,495	\$	5,495	\$	5,495	\$	5,495	\$	5,495
	1 4	4.0-		25-	_	05-		0.5-	_	25-	_	95-
	\$ 128 \$			255	\$	255	\$	255	\$	255	\$	255
	_	07.404	_	404.250	_	404.250	_	404.250	_	404.200	_	404.000
	\$97,184			194,368	_	194,368	,	194,368	_	194,368	Ş	194,368

CIAC Table			Accun	nula	ted Amorti	zati	on		
Year	2024	2025	2026		2027		2028	2029	2030
Annual CIAC - Plant	\$ -	\$ 4,054	\$ 15,241	\$	32,587	\$	56,090	\$ 85,752	\$ 121,572
Annual CIAC - T&D	\$ -	\$ 28,674	\$ 86,021	\$	143,368	\$	200,716	\$ 258,063	\$ 315,410
	\$0	\$32,728	\$101,262		\$175,955		\$256,806	\$343,815	\$436,982

			Am	orti	zation Expe	ense	9		
ı	2024	2025	2026		2027		2028	2029	2030
ı	\$	\$ 4,054	\$ 11,187	\$	17,345	\$	23,504	\$ 29,662	\$ 35,820
	\$	\$ 28,674	\$ 57,347	\$	57,347	\$	57,347	\$ 57,347	\$ 57,347
	\$0	\$32,728	\$68,535		\$74,693		\$80,851	\$87,009	\$93,167

			<u> </u>	Annual	Plant Additions		<u> </u>	<u> </u>
Туре	2024	2025	2026	2027	2028	2029	2030	TOTAL
Cumm. Homes	0	85	175	265	355	445	535	
Sewer Laterals								\$0
361 Collec. Sys		\$902,981						\$902,981
361 Manholes		\$1,087,500						\$1,087,500
360 Force Main		\$902,981						\$902,981
354 Lift Stations Struct		\$71,875						\$71,875
371 Lift Stations Equip		\$71,875						\$71,875
354 WWTP Structures		\$2,179,638						\$2,179,638
381 WWTP Equipment		\$1,500,000						\$1,500,000
382 Oufall (RIBs)		\$43,725						\$43,725
Organization Cost (2023-2024) Milian, Swain & Associates	4,000							
Friedman & Friedman	4,000							
Internal costs	1,000							
Filing Fee	1,000							
Expense	200							
Organization Cost	\$10,200	\$0	\$0	\$0	\$0	\$0		\$10,200
TOTAL	\$10,200	\$6,760,576	\$0	\$0	\$0	\$0	\$0	\$6,770,776
CUMULATIVE	\$10,200	\$6,770,776	\$6,770,776	\$6,770,776	\$6,770,776	\$6,770,776	\$6,770,776	•

CIAC Table - PROPOSED RATES								
Fee - Plant	\$ 3,000.00							
Fee - T&D	\$ -							
Total cost	2,893,463	Schedule 1B						
Total Factored ERCs	569	Capacity						
V	2024	2025	2026	2027	2020	2020	2020	
Year	2024	2025	2026	2027	2028	2029	2030	TOTAL
Factored ERCs	0	119	90	90	90	90	90	569
Annual CIAC - Plant	\$0	\$355,500	\$270,000	\$270,000	\$270,000	\$270,000	\$270,000	\$1,705,500
Annual CIAC - T&D	\$0	\$2,692,425	\$0	\$0	\$0	\$0	\$0	\$2,692,425
TOTAL		\$3,047,925	\$270,000	\$270,000	\$270,000	\$270,000	\$270,000	\$4,397,925

North Lake County Water & Sewer Company LLC Wastewater Plant, Depreciation, CIAC and Amortization

	Depreciation						A	nnual addi	tion f	or year				
Туре	Life	2024		2025		2026		2027		2028		2029	2	030
Cumm. Homes														
Sewer Laterals	38		\$	-	\$	-	\$	-	\$	-	\$	-	\$	-
Collec. Sys	45		\$	20,066	\$	-	\$		\$	-	\$	-	\$	-
Collec. Sys	45		\$	24,167	\$	-	\$	-	\$	-	\$	-	\$	-
Force Main	30		\$	30,099	\$	-	\$	1	\$	-	\$	-	\$	-
Lift Stations Struct	32		\$	2,246	\$	-	\$	-	\$	-	\$	-	\$	-
Lift Stations Equip	18		\$	3,993	\$	-	\$	-	\$	-	\$	-	\$	-
WWTP Structures	32		\$	68,114	\$	-	\$	-	\$	-	\$	-	\$	-
WWTP Equipment	18		\$	83,333	\$	-	\$		\$	-	\$	-	\$	-
WWTP Equipment	18		\$	2,429	\$	-	\$	-	\$	-	\$	-	\$	-
Organization Cost	40		l ė	255	ė		¢		ė		ė		ė	
Organization Cost	40		\$	255	\$	-	\$	-	\$	-	\$	-	\$	
TOTAL														

	PLANT	T&D	Total
Total Exp	\$ 160,370	\$ 74,332	\$ 234,703
Total Plant	\$3,877,313	\$2,893,463	\$ 6,770,776
%	4.14%	2.57%	3.47%
Years	24.18	38.93	28.85

CIAC Table				Annual a	ddit	ions - Accu	m A	mort		
Year	Amortization	2024	2025	2026		2027		2028	2029	2030
Annual CIAC - Plant	24.18	\$ -	\$ 14,704	\$ 11,168	\$	11,168	\$	11,168	\$ 11,168	\$ 11,168
Annual CIAC - T&D	38.93	\$ -	\$ 69,168	\$	\$	-	\$	-	\$ -	\$ -
			\$83,872	\$11,168		\$11,168		\$11,168	\$11,168	\$11,168

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Docket No.:

							A	ccumulated	De	preciation				
Туре		2024		2025		2026		2027		2028		2029		2030
Cumm. Homes														
Sewer Laterals	\$	-	\$	-	\$	-	\$	-	\$	-	\$	-	\$	-
Collec. Sys	\$	-	\$	10,033	\$	30,099	\$	50,166	\$	70,232	\$	90,298	\$	110,364
Collec. Sys	\$	-	\$	12,083	\$	36,250	\$	60,417	\$	84,583	\$	108,750	\$	132,917
Force Main	\$	-	\$	15,050	\$	45,149	\$	75,248	\$	105,348	\$	135,447	\$	165,547
Lift Stations Struct	\$	-	\$	1,123	\$	3,369	\$	5,615	\$	7,861	\$	10,107	\$	12,354
Lift Stations Equip	\$	-	\$	1,997	\$	5,990	\$	9,983	\$	13,976	\$	17,969	\$	21,962
Wastewater Treatment	\$	-	\$	34,057	\$	102,171	\$	170,284	\$	238,398	\$	306,512	\$	374,625
Wastewater Treatment	\$	-	\$	41,667	\$	125,000	\$	208,333	\$	291,667	\$	375,000	\$	458,333
Wastewater Treatment	\$	-	\$	1,215	\$	3,644	\$	6,073	\$	8,502	\$	10,931	\$	13,360
Organization Cost	\$		\$	128	Ś	383	Ś	638	Ś	893	\$	1,148	\$	1,403
Organización Cost	ې	-	۲	120	٧	303	Ą	036	۲	033	۲	1,140	۲	1,403
TOTAL			Ş	117,351	\$	352,054	-	\$586,757	Ş	\$821,459	\$1	1,056,162	\$1	1,290,865

				Dep	rec	iation Expe	ense)			
2024		2025		2026		2027		2028	2029		2030
\$ -	\$	-	\$	-	\$	-	\$	-	\$ -	\$	-
\$ -	\$	10,033	\$	20,066	\$	20,066	\$	20,066	\$ 20,066	\$	20,066
\$ -	\$	12,083	\$	24,167	\$	24,167	\$	24,167	\$ 24,167	\$	24,167
\$	\$	15,050	\$	30,099	\$	30,099	\$	30,099	\$ 30,099	\$	30,099
\$ -	\$	1,123	\$	2,246	\$	2,246	\$	2,246	\$ 2,246	\$	2,246
\$ -	\$	1,997	\$	3,993	\$	3,993	\$	3,993	\$ 3,993	\$	3,993
\$ -	\$	34,057	\$	68,114	\$	68,114	\$	68,114	\$ 68,114	\$	68,114
\$ -	\$	41,667	\$	83,333	\$	83,333	\$	83,333	\$ 83,333	\$	83,333
\$ -	\$	1,215	\$	2,429	\$	2,429	\$	2,429	\$ 2,429	\$	2,429
	\$	128	\$	255	\$	255	\$	255	\$ 255	\$	255
40	_					1001				_	
\$0 \$117,351			5	234,703	,	\$234,703	Š	234,703	234,703	\$	234,703

CIAC Table				Accum An	nor	ization		
Year	2024	2025	2026	2027		2028	2029	2030
Annual CIAC	\$ -	\$ 7,352	\$ 27,640	\$ 59,095	\$	101,718	\$ 155,508	\$ 220,466
Annual CIAC	\$ -	\$ 34,584	\$ 103,752	\$ 172,919	\$	242,087	\$ 311,255	\$ 380,422
	\$0	\$41,936	\$131,391	\$232,014		\$343,804	\$466,762	\$600,888

Amortization Expense										
2024		2025		2026		2027		2028	2029	2030
\$ -	\$	7,352	\$	20,288	\$	31,455	\$	42,623	\$ 53,790	\$ 64,958
\$ -	\$	34,584	\$	69,168	\$	69,168	\$	69,168	\$ 69,168	\$ 69,168
\$0		\$41,936		\$89,455		\$100,623		\$111,790	\$122,958	\$134,125

North Lake County Water & Sewer Company LLC Initial Rates and Charges Projected Net Operating Income Projected December 31, 2029

Line No.			jected Costs		dditional renues and RAFs	2026 Required Revenues	
1	Water						
2	Operating Revenue			\$	487,143	\$	487,143
3							
4	Operating Expenses						
5	Operation & Maintenance Expenses	\$	58,946			\$	58,946
6	Depreciation net of CIAC Amortization		107,104				107,104
7	Amortization		255				255
8	Taxes Other Than Income		46,451	\$	21,921		68,373
9	Total Operating Expenses	\$	212,757	\$	21,921	\$	234,678
10							
11	Net Operating Income (Loss)	\$	(212,757)	\$	465,221	\$	252,464
12						-	 -
13	Rate Base	\$	3,067,612			\$	3,067,612
14							
15	Rate of Return						8.23%
16							
17							
18	Wastewater						
19	Operating Revenue			\$	427,771	\$	427,771
20				<u> </u>			<u> </u>
21	Operating Expenses						
22	Operation & Maintenance Expenses	\$	58,946			\$	58,946
23	Depreciation net of CIAC Amortization		111,490				111,490
24	Amortization		255				255
25	Taxes Other Than Income		33,247	\$	19,250		52,497
26	Total Operating Expenses	\$	203,938	\$	19,250	\$	223,188
27						-	
28	Net Operating Income (Loss)	\$	(203,938)	\$	408,521	\$	204,583
29						===	
30	Rate Base	\$	2,485,820			\$	2,485,820
31		<u> </u>	,,-			<u> </u>	,,-
32	Rate of Return						8.23%

North Lake County Water & Sewer Company LLC Initial Rates and Charges Water System

Calculation of Rates for Water Utility based on projections 12/31/2029

			2026	Allocation I	Percentage	Allocation	Amount
Line	NARUC		Total Revenue	Base Facility		Base Facility	Gallonage
No. 1	Acct. No. 601	Description Salaries and Wages - Employees	Requirement	Charge	Charge	Charge	Charge
2	603	Salaries and Wages - Other					
3	604	Employees Pensions and Benefits					
4	610	Purchased Water					
5	615	Purchased Power	-	50%	50%	-	-
6	616	Fuel for Power Production					
7	618	Chemicals	-	50%	50%	-	-
8	620	Materials and Supplies					
9	630	Contract Services - Plant Operations	16,971	50%	50%	8,486	8,486
10	630	Contract Services - Billing	36,318	50%	50%	18,159	18,159
11	630	Contract Service - Engineering	2,829	50%	50%	1,414	1,414
12	630	Contract Service - Accounting	2,829	50%	50%	1,414	1,414
13	640	Rents					
14 15	650 655	Transportation Expense					
16	665	Insurance Expense Regulatory Commission Expense					
17	670	Bad Debt Expense					
18	675	Miscellaneous Expense					
19		Total Operations & Maintenance Expenses	\$ 58,946	_		\$ 29,473	\$ 29,473
20				= '			
21	403	Depreciation - Net of CIAC Amortization	107,104	50%	50%	53,552	53,552
22	407	Annual de la Company	255	F00/	F00/	420	120
23 24	407	Amortization Expense - Org Cost	255	50%	50%	128	128
25	408	Taxes Other Than Income	68,373	50%	50%	34,186	34,186
26						,	. ,
27		Net Operating Income	252,464	50%	50%	126,232	126,232
28							
27		Less: Revenues from Miscellaneous Charges	(3,375)	50%	50%	(1,688)	(1,688)
28 29		Total Revenue Requirement from Rates	\$ 483,768			\$ 241,883	\$ 241,883
30		Total Nevenue Nequilement from Nates	3 403,700	=		ÿ 241,003	7 241,003
31		Factored Bills (Monthly factored bills X 12)				5,520	
32		Annual Billable Gallons				,	62,379
33							
34		Base Facility Charge				\$ 43.82	
35							
36		Gallonage Charge (per 1,000)					
37		Residential under 3000 gls	39,367			=	\$ 4.59
38		Residential over 3000 gls	7,499)		.	\$ 5.74
39		General Service	3,796	i		=	\$ 4.77
40							
41							
42		Monthly factored bills		<u>80</u>		1009	
43 44		5/8" (Res)	1	Bills 428	Factored 428	Bills 535	Factored 535
45		5/8" (Comm)	1		428 0	0	0
46		3/4"	1.5		0	0	0
47		1"	2.5		0	0	0
48		1-1/2"	5	0	0	0	0
49		2"	8		16	2	16
50		3"	16	1	16	1	16
51 52				431	460	538	567
53				431	400	338	307
54		Annual billable gallons					
55							
56		Residential Gallons (300 gpd)		46,866	428	58,583	535
57		Under 7,000 gls (84%)		39,367		49,209	
58		Over 7,000 gls (16%)		7,499		9,373	
59		General Service Gallons (325 gpd/ERC)		3,796	32	3,796	32
60				50,662	460	62,379	567

North Lake County Water & Sewer Company LLC Initial Rates and Charges Wastewater System

Calculation of Rates for Wastewater Utility based on projections 12/31/2029

			2038	Allocation P	-	Allocation	
Line	NARUC	Daniel III	Total Revenue	Base Facility	Gallonage	Base Facility	Gallonage
No. 1	Acct. No.	Description Operations & Maintenance Expenses	Requirement	Charge	Charge	Charge	Charge
2	701	Salaries and Wages - Employees					
3	701	Salaries and Wages - Other					
4	703	Employees Pensions and Benefits					
5	710	Purchased Wastewater Treatment	_	50%	50%	_	_
6	711	Sludge Removal Expense	_	3070	3070		
7	715	Purchased Power	_	50%	50%	_	_
8	716	Fuel for Power Production	_	30,0	3070		
9	718	Chemicals	_	50%	50%	_	-
10	720	Materials and Supplies	_			_	
11	730	Contract Services - Plant Operations	16,971	50%	50%	8,486	8,486
12	730	Contract Services - Billing	36,318	50%	50%	18,159	18,159
13	730	Contract Services - Engineering	2,829	50%	50%	1,414	1,414
14	740	Contract Services - Accounting	2,829	50%	50%	1,414	1,414
15	750	Rents	,			, -	_
16	755	Transportation Expense					
17	765	Insurance Expense				-	_
18	770	Regulatory Commission Expense				_	-
19	775	Bad Debt Expense					
20		Miscellaneous Expense					
21		Total Operations & Maintenance Expenses	\$ 58,946			\$ 29,473	29,473
22	403						
23		Depreciation - Net of CIAC Amortization	111,490	50%	50%	55,745	55,745
24	407						
25		Amortization Expense - Org Cost	255	50%	50%	128	128
26	408	Tarras Othan Than Income	F2 407	F00/	F00/	26.240	26.240
27 28		Taxes Other Than Income	52,497	50%	50%	26,248	26,248
29		Net Operating Income	204,583	50%	50%	102,291	102,291
30		net operating meanic	204,303	3070	3070	102,231	102,231
31		Less: Revenues from Miscellaneous Charges	(3,375)	50%	50%	(1,688)	(1,688)
32		· ·	, ,				, , ,
33		Total Revenue Requirement from Rates	\$ 424,396			\$ 212,197	212,197
34				•		-	
35		Factored Bills (Monthly factored bills X 12)				5,520	
36		Annual Billable Gallons					42,559
37							
38		Base Facility Charge				\$ 38.44	
39		0.11 01 (4.000) 0 :1 ::1					
40		Gallonage Charge (per 1,000) - Residential				=	
41		Gallonage Charge (per 1,000) - General Service				=	5.89
42 43		Monthly factored bills		809	,	1000	,
43 44		Wonthly factored bills		Bills	<u>^•</u> Factored	1009 Bills	<u>^•</u> Factored
45		5/8" (Res)	1	428	428	535	535
46		5/8" (Comm)	1	0	0	0	0
47		3/4"	1.5	0	0	0	0
48		1"	2.5	0	0	0	C
49		1-1/2"	5	0	0	0	C
50		2"	8	2	16	2	16
51		3"	16	1	16	1	16
52							
53				431	460	538	567
54							
55		Annual billable gallons		Annual	<u>Adjusted</u>	Annual	<u>Adjusted</u>
56 57		Residential Gallons (300gpd water, 250gpd sewer)		39,055	31,244	48,819	39,055
57 58		General Service Gallons		3,504 42,559	3,364 34,608	3,504 52,323	3,364
20				42,339	34,008	32,323	42,419

Exhibit VI-A

EXHIBIT "A"

PROPOSED UTILITY SERVICE AREA

LEGAL DESCRIPTION:

(WATER AND SEWER UTILITY SERVICES)

A PARCEL OF LAND LYING IN SECTION 15 AND 22, TOWNSHIP 20 SOUTH, RANGE 25 EAST BEING DESCRIBED AS FOLLOWS:


COMMENCE AT NORTH QUARTER CORNER OF SAID SECTION 22 FOR A POINT OF REFERENCE; THENCE RUN NORTH 89'14'57" WEST. 670.22 FEET TO THE EASTERLY RIGHT-OF-WAY LINE OF COUNTY ROAD 48 (F.K.A. STATE ROAD 212) AND THE POINT OF BEGINNING; THENCE RUN THE FOLLOWING 4 COURSES ALONG SAID EASTERLY RIGHT-OF-WAY LINE, NORTH 23°24'43" WEST, 1531.02 FEET; THENCE RUN SOUTH 66°37'55" WEST, 16.97 FEET; THENCE NORTH 2018'28" WEST, 226.54 FEET; **THENCE DEPARTING** SAID EAST RIGHT-OF-WAY LINE THE NORTH 20'34'23" WEST, NORTH 20'00'00" WEST, 201.94 FEET; **THENCE** RUN 317.00 FEET; THENCE RUN NORTH 19'50'21" WEST, 405.58 FEET; **THENCE** RUN NORTH 69'59'13" EAST, 210.05 FEET; **THENCE** RUN SOUTH 19'51'32" EAST. 406.34 FEET: **THENCE** RUN NORTH 70'07'30" EAST. 622.19 FEET: THENCE RUN NORTH 02°08'18" EAST, 961.62 FEET TO A POINT ON THE 62.5 FOOT CONTOUR LINE, BEING THE FLORIDA DEPARTMENT OF ENVIRONMENTAL PROTECTION "SAFE UPLAND" LINE OF THE WATERS OF LAKE HARRIS, THENCE RUN ALONG SAID SAFE UPLAND" LINE CONTOUR BEING APPROXIMATED BY THE FOLLOWING COURSES: SOUTH 48'13'31" EAST, 171.61" FEET, SOUTH 30'28'21" EAST, 198.50 FEET, SOUTH 89'28'36" EAST, 214.54 FEET, SOUTH 75'33'09" EAST, 163.02 FEET, SOUTH 64°37'20" EAST, 195.83 FEET, SOUTH 81°24'01" EAST, 185.82 FEET, SOUTH 83°21'55" EAST, 150.78 FEET, NORTH 82'35'47" EAST, 145.75 FEET, NORTH 88'37'02" EAST, 289.27 FEET, NORTH 82'48'31" EAST, 99.43 FEET, SOUTH 72'51'05" EAST, 124.28 FEET, SOUTH 49'04'35" EAST, 589.31 FEET, SOUTH 68'28'09" EAST, 696.95 FEET, SOUTH 83'52'42" EAST, 390.31 FEET, NORTH 79'30'03" EAST, 312.29 FEET, SOUTH 77'09'39" EAST, 405.31 FEET, SOUTH 18'43'07" EAST, 72.17 FEET, SOUTH 64'24'04" EAST. 290.41. SOUTH 32'23'54" WEST. SOUTH 47'59'25" WEST, 306.08 FEET, SOUTH 34'28'28" WEST, 160.69 FEET, SOUTH 22'19'42" WEST, 170.42 FEET, SOUTH 02'47'59" EAST, 173.67 FEET, SOUTH 24'39'51" WEST, 379.39 FEET, SOUTH 20'53'09" WEST, 129.67 FEET, SOUTH 10°47'41" WEST, 262.36 FEET, SOUTH 04°51'48" WEST, 356.75 FEET, SOUTH 06°43'37" WEST, 125.96 FEET, POINT BEING 100.00 FEET EASTERLY OF THE NORTHEAST CORNER OF THE AFORESAID SECTION 22; THENCE RUN NORTH 89°32°11" WEST, 100.00 FEET TO THE NORTHEAST CORNER OF THE AFORESAID SECTION 22; THENCE RUN NORTH 89'32'11" WEST, ALONG THE NORTH LINE OF THE NORTHEAST QUARTER OF SAID SECTION 22, A DISTANCE OF, 1350.44 FEET; THENCE DEPARTING SAID NORTH LINE, RUN SOUTH 40'37'42" WEST, 872.91 FEET TO THE SOUTH LINE OF THE NORTHEAST QUARTER OF THE NORTHWEST QUARTER OF THE NORTHEAST QUARTER OF SAID SECTION 22; THENCE RUN NORTH 89°23'03" WEST, ALONG SAID SOUTH LINE, 73.32 FEET TO THE NORTHEAST CORNER OF THE SOUTHWEST QUARTER OF THE NORTHWEST QUARTER OF THE NORTHEAST QUARTER OF SAID SECTION 22; THENCE RUN SOUTH 01'02'44" WEST, THE EAST LINE OF THE SOUTHWEST QUARTER OF THE NORTHWEST QUARTER OF THE NORTHEAST QUARTER OF SAID SECTION 22, A DISTANCE OF 666.91 FEET TO THE SOUTHEAST CORNER OF SOUTHWEST QUARTER OF THE NORTHWEST QUARTER OF THE NORTHEAST QUARTER OF SAID SECTION 22; THENCE RUN NORTH 89°13'56" WEST ALONG THE SOUTH LINE OF SOUTHWEST QUARTER OF THE NORTHWEST QUARTER OF THE NORTHEAST QUARTER OF SAID SECTION 22, A DISTANCE OF 47.47 FEET; THENCE RUN SOUTH 31°25'16" WEST, 1.75 FEET; THENCE RUN SOUTH 62'36'34" WEST, 98.66'; THENCE RUN SOUTH 34'07'05" WEST, 113.15 FEET; THENCE RUN SOUTH 67'31'03" WEST, 41.43 FEET; THENCE RUN SOUTH 72'42'59" WEST, 159.42; THENCE RUN SOUTH 65'14'08" WEST, 143.37 FEET; THENCE RUN SOUTH 76'24'55" WEST, 72.29 FEET TO A POINT ON THE AFORESAID EAST RIGHT-OF-WAY OF COUNTY ROAD 48, SAID POINT IS LYING ON A NON-TANGENT CURVE CONCAVE NORTHWESTERLY; THENCE RUN NORTHWESTERLY ALONG SAID NON-TANGENT CURVE HAVING A RADIUS OF 5679.57 FEET, A CENTRAL ANGLE OF 03°34'40", AN ARC LENGTH OF 354.66 FEET, A CHORD LENGTH OF 354.60 FEET, AND A CHORD BEARING OF NORTH 24'58'35" WEST TO A POINT; THENCE RUN NORTH 23'24'43" WEST, NON-TANGENT TO SAID CURVE, 1423.66 FEET TO THE POINT OF BEGINNING.


THE ABOVE DESCRIBED PARCEL OF LAND LIES IN LAKE COUNTY, FLORIDA AND CONTAINS 293.810 ACRES MORE OR LESS.




PEC | SURVEYING AND MAPPING, LLC


2100 Alafaya Trail, Suite 203 • Oviedo, Florida 32765 • 407–542–4967 WWW.PECONLINE.COM

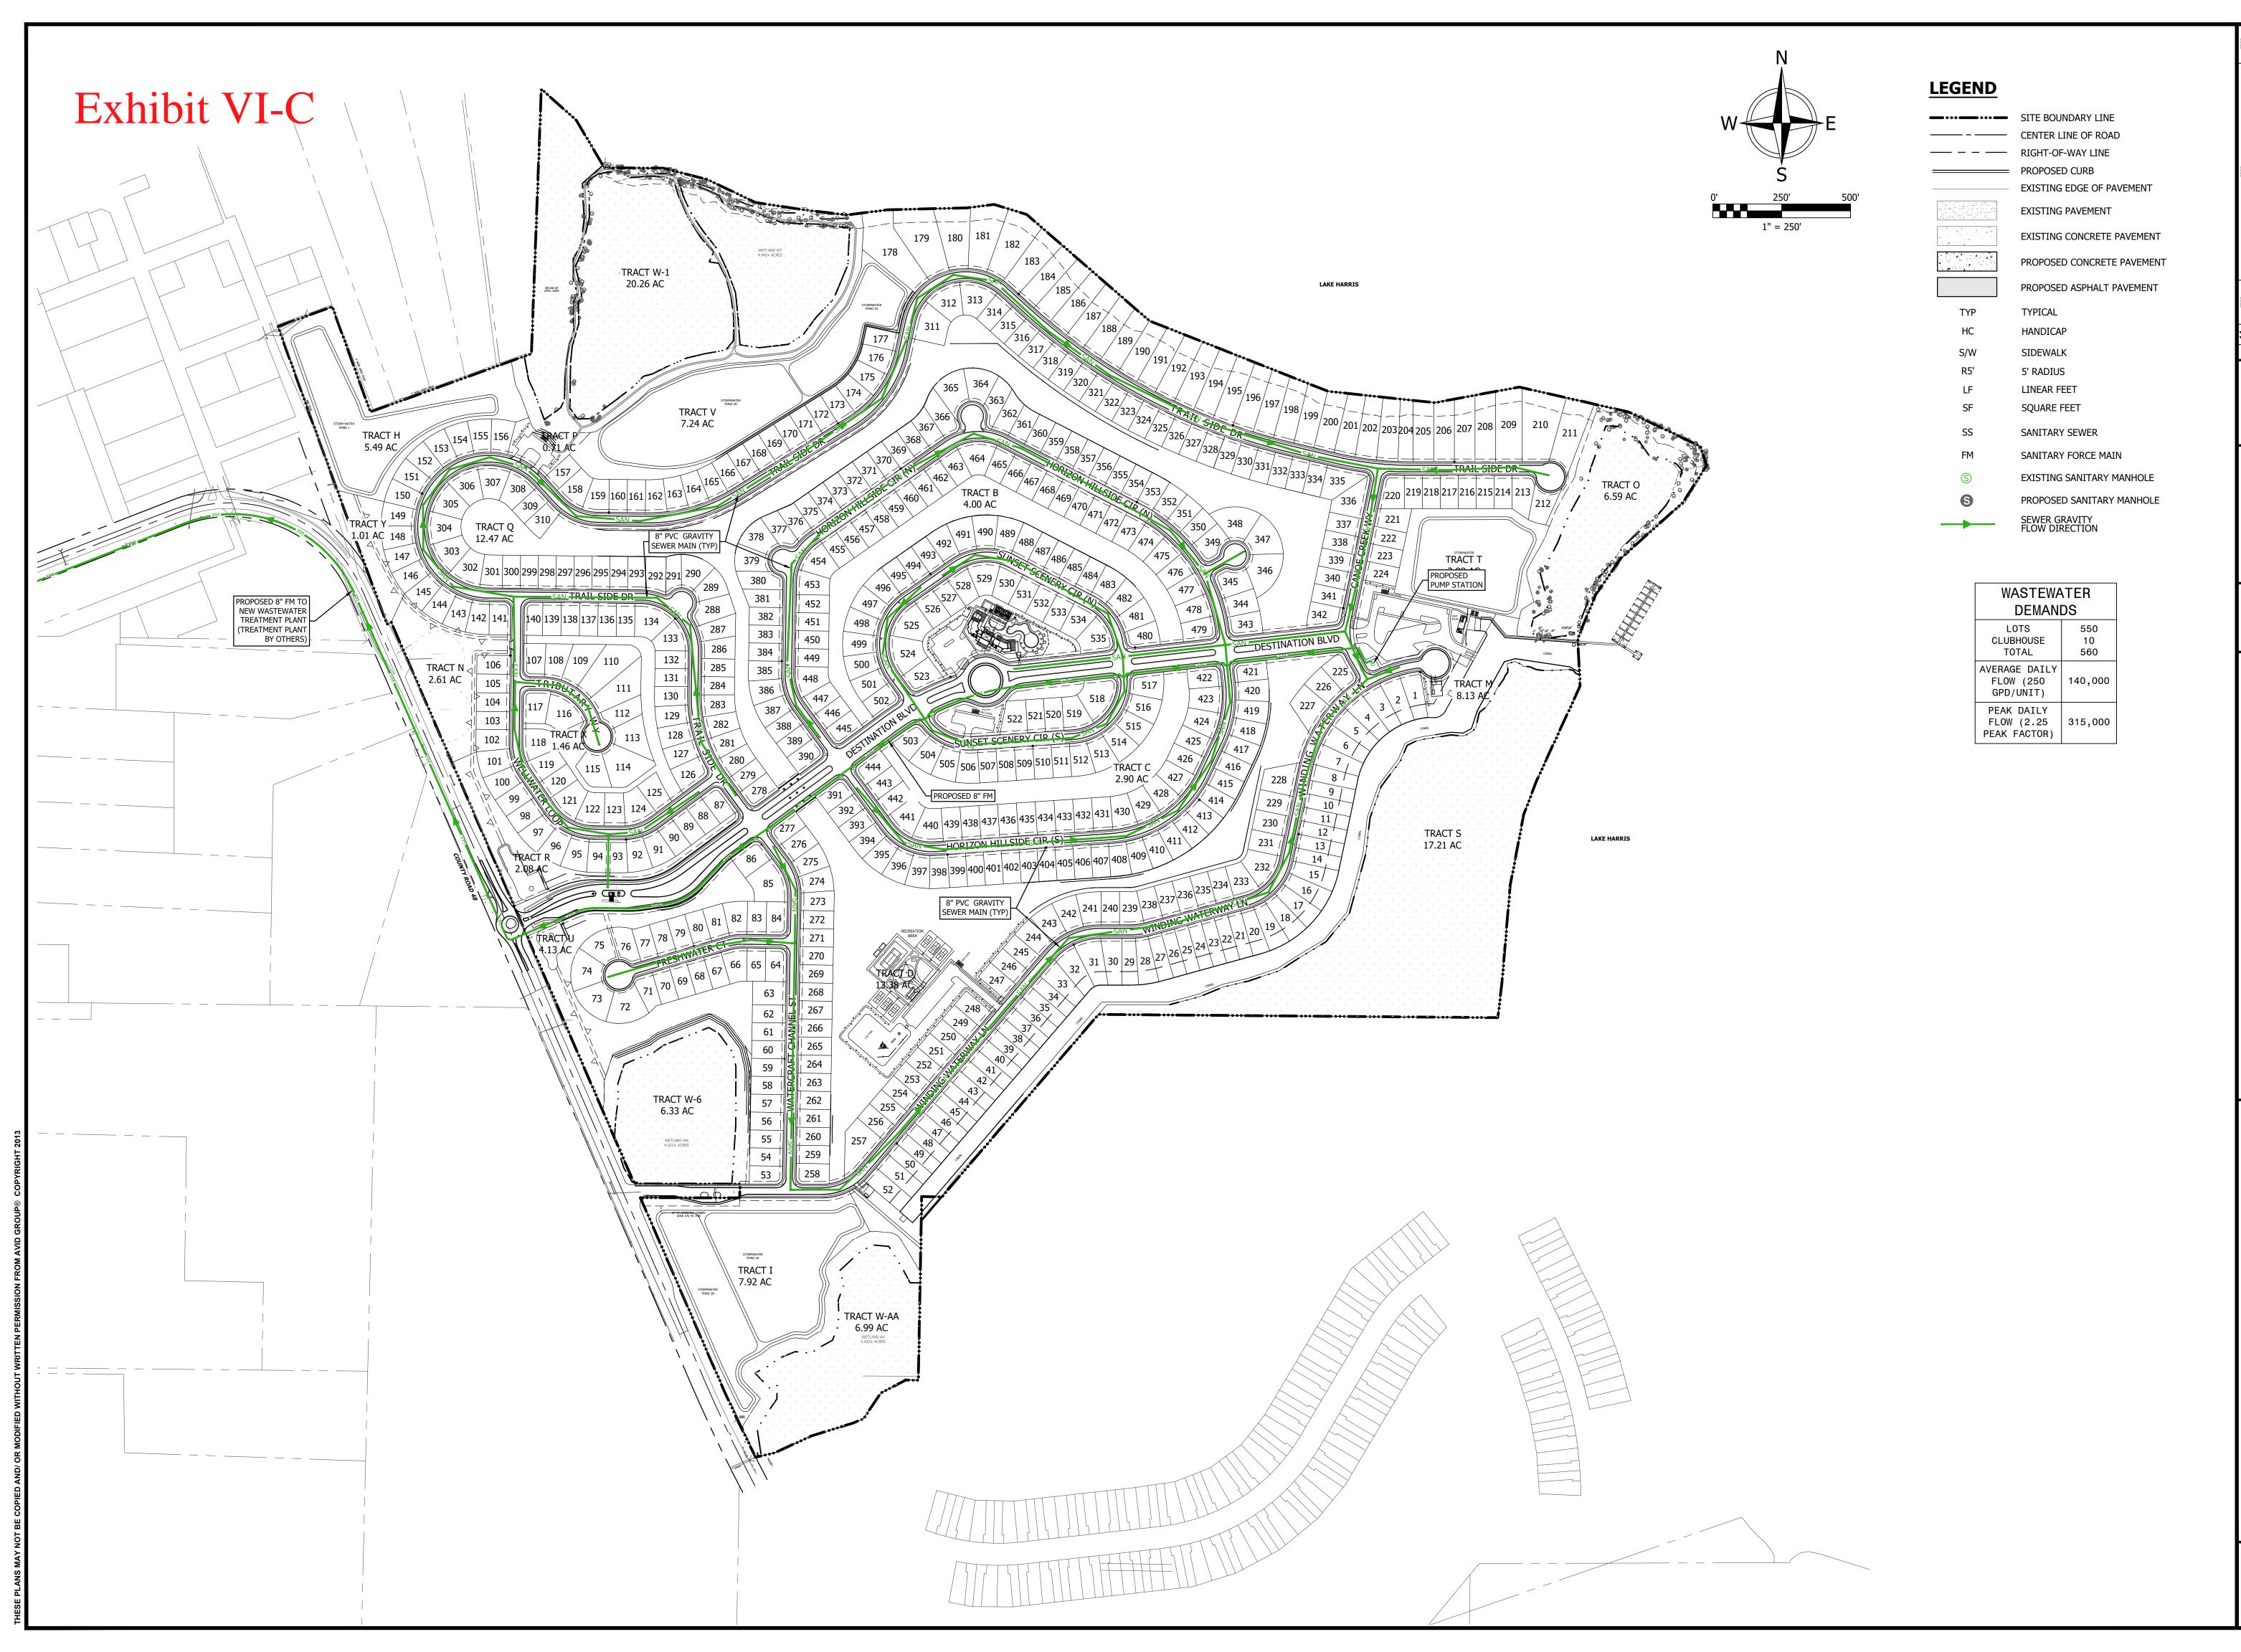

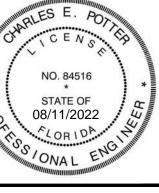


GPK HOLI

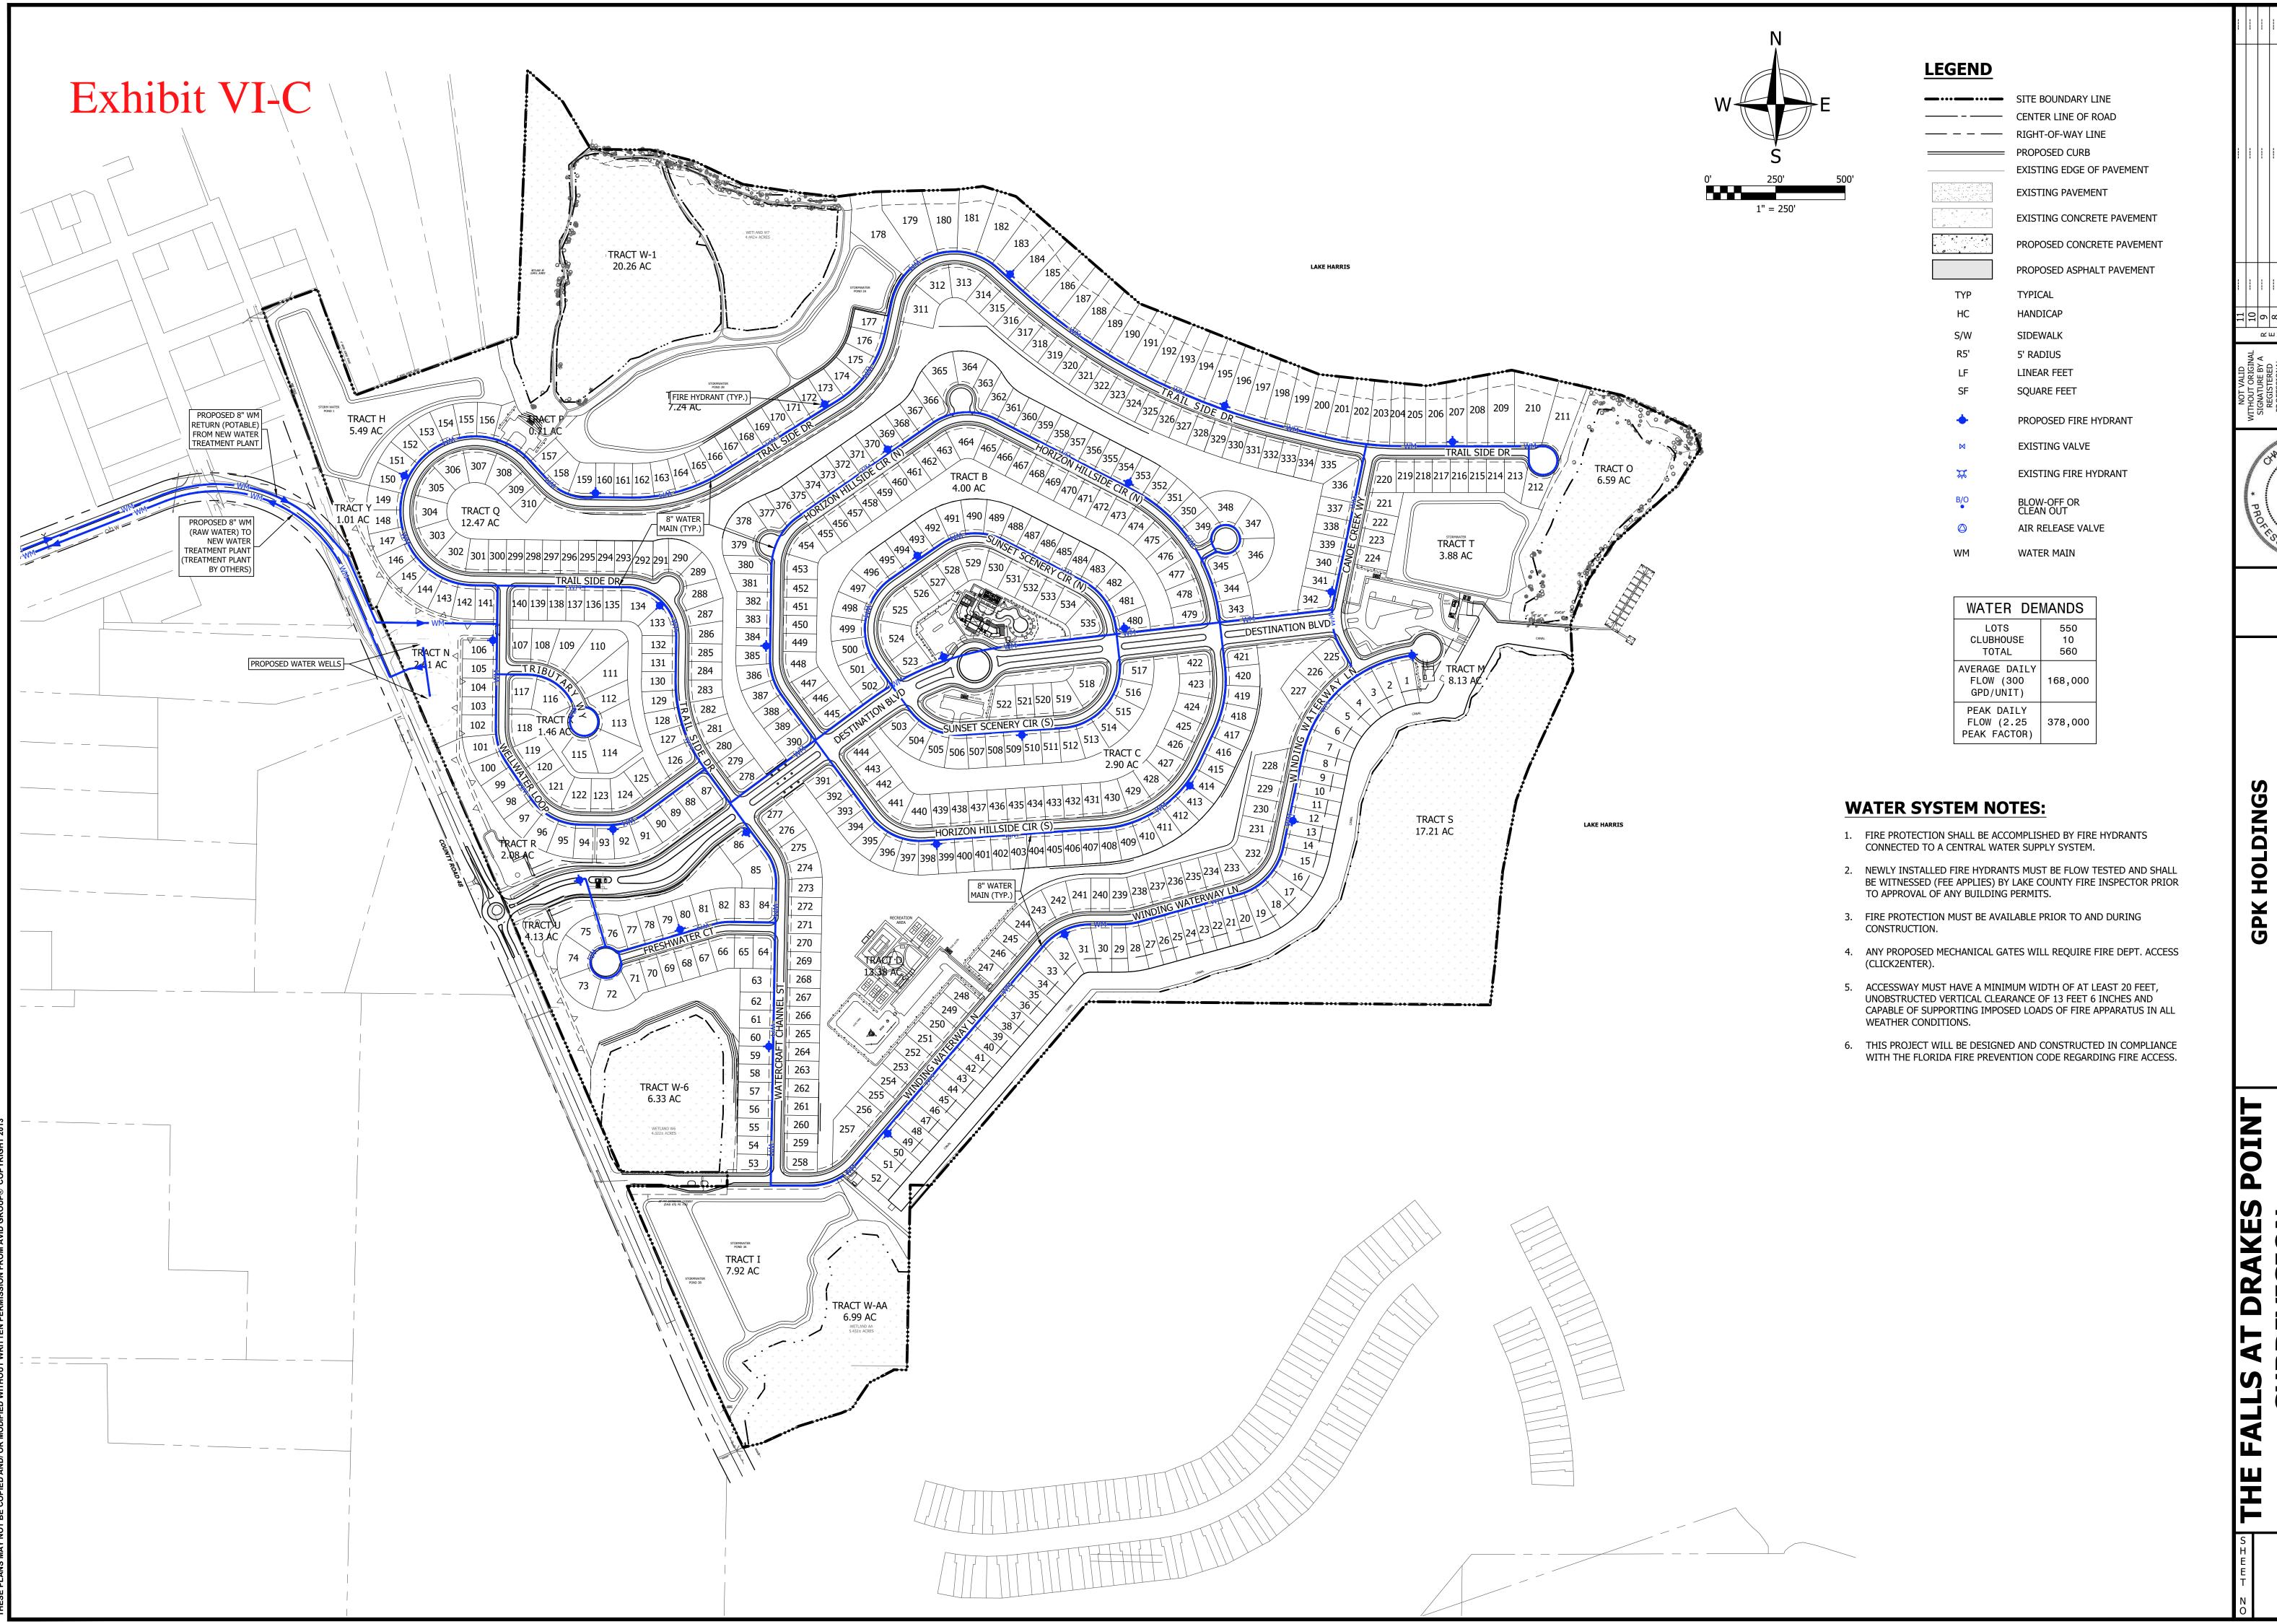

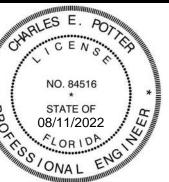



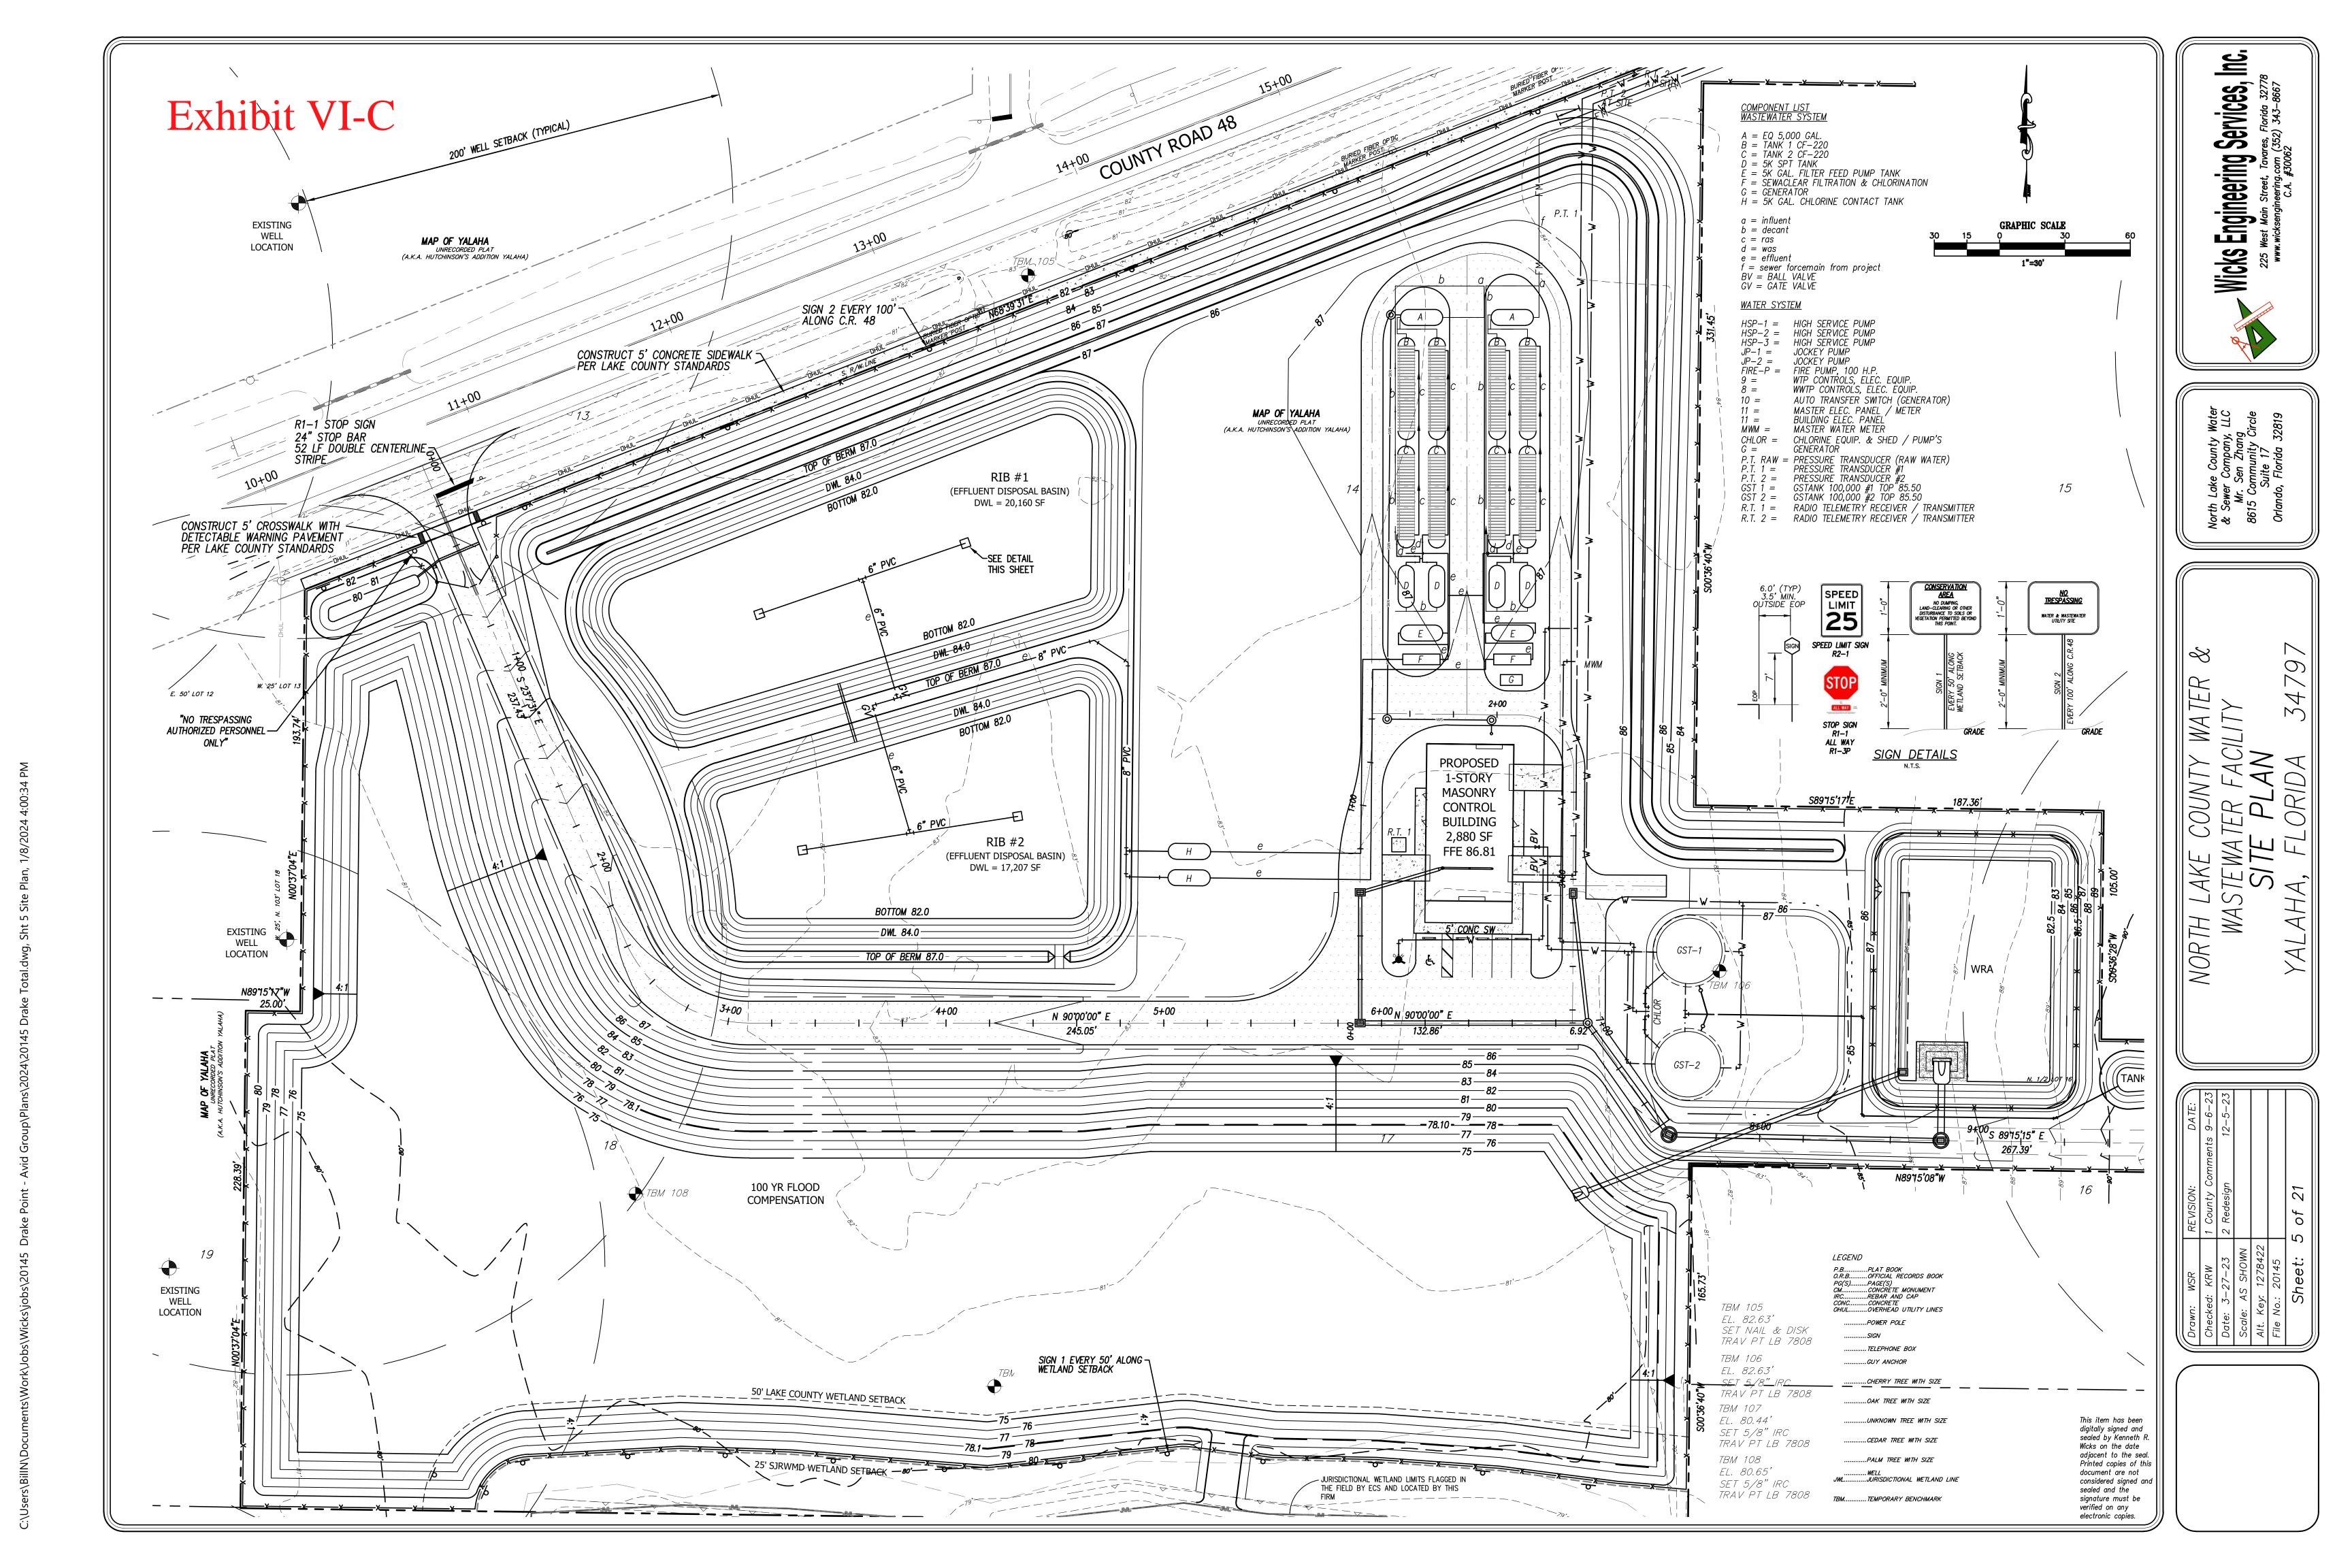

NOTICE OF APPLICATION FOR ORIGINAL CERTIFICATE OF AUTHORIZATION AND INITIAL RATES AND CHARGES FOR WATER AND WASTEWATER SERVICE

Docket No. 2024____-WS - Application for certificates to provide water and wastewater service by North Lake County Water & Sewer Company, LLC in Lake County

Notice is hereby given on the ____ day of January, 2024, pursuant to Section 367.045, Florida Statutes, and Section 25-30.030, Florida Administrative Code, of the Application for Original Water and Wastewater Certificates in Lake County by North Lake County Water & Sewer Company, LLC. The Certificates will authorize North Lake County Water & Sewer Company, LLC to provide water and wastewater service in Sections 15 and 22 in Township 20 South, Range 25 East, in Lake County, which borders Lake Harris. This legal description has been simplified and to obtain a copy of the exact legal description please contact Martin Friedman at 407-310-2077 or mfriedman@deanmead.com.

Any objections to the Application must be made in writing and filed with the Commission Clerk, Office of Commission Clerk, Florida Public Service Commission, 2540 Shumard Oak Boulevard, Tallahassee, Florida 32399-0850, no later than 30 days from the date of this Notice, with a copy to Martin S. Friedman, Esquire, Dean Mead, 420 S. Orange Ave., Suite 700, Orlando, Florida 32801, which may be emailed to mfriedman@deanmead.com. The objection must state the grounds for the objection with particularity.

North Lake County Water & Sewer Company, LLC 8615 Commodity Cir., Suite 17 Orlando, FL 32819

WASTEWATER TARIFF

NORTH LAKE COUNTY WATER & SEWER COMPANY, LLC NAME OF COMPANY

FILED WITH
FLORIDA PUBLIC SERVICE COMMISSION

WASTEWATER TARIFF

NORTH LAKE COUNTY WATER & SEWER COMPANY, LLC NAME OF COMPANY

8615 Commodity Cir., Suite 17

Orlando, Florida 32819 (ADDRESS OF COMPANY)

(Business & Emergency Telephone Number)

FILED WITH
FLORIDA PUBLIC SERVICE COMMISSION

Sen Zhang ISSUING OFFICER

Chief Operations Officer

TITLE

WASTEWATER TARIFF

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TERRITORY AUTHORITY

CERTIFICATE NUMBER - ___-S

COUNTY -Lake

COMMISSION ORDER(s) APPROVING TERRITORY SERVED -

<u>Order Number</u> <u>Date Issued</u> <u>Docket Number</u> Filing Type

> Sen Zhang ISSUING OFFICER

DESCRIPTION OF TERRITORY SERVED

A PARCEL OF LAND LYING IN SECTION 15 AND 22, TOWNSHIP 20 SOUTH, RANGE 25 EAST BEING DESCRIBED AS FOLLOWS:

COMMENCE AT NORTH QUARTER CORNER OF SAID SECTION 22 FOR A POINT OF REFERENCE; THENCE RUN NORTH 89'14'57" WEST, 670.22 FEET TO THE EASTERLY RIGHT-OF-WAY LINE OF COUNTY ROAD 48 (F.K.A. STATE ROAD 212) AND THE POINT OF BEGINNING; THENCE RUN THE FOLLOWING 4 COURSES ALONG SAID EASTERLY RIGHT-OF-WAY LINE, NORTH 23'24'43" WEST, 1531.02 FEET; THENCE RUN SOUTH 66'37'55" WEST, 16.97 FEET; THENCE RUN NORTH 2018'28" WEST, 226.54 FEET; THENCE DEPARTING SAID EAST RIGHT-OF-WAY LINE RUN NORTH 20'34'23" WEST, 201.94 FEET; THENCE RUN NORTH 20'00'00" WEST, 317.00 FEET; RUN NORTH 19'50'21" WEST, 405.58 FEET; THENCE RUN NORTH 69'59'13" EAST, 210.05 FEET; RUN SOUTH 19'51'32" EAST, 406.34 FEET; THENCE RUN NORTH 70'07'30" EAST, 622.19 FEET; THENCE RUN NORTH 02'08'18" EAST, 961.62 FEET TO A POINT ON THE 62.5 FOOT CONTOUR LINE, BEING THE FLORIDA DEPARTMENT OF ENVIRONMENTAL PROTECTION "SAFE UPLAND" LINE OF THE WATERS OF LAKE HARRIS, THENCE RUN ALONG SAID SAFE UPLAND" LINE CONTOUR BEING APPROXIMATED BY THE FOLLOWING COURSES: SOUTH 48'13'31" EAST, 171.61" FEET, SOUTH 30'28'21" EAST, 198.50 FEET, SOUTH 89'28'36" EAST, 214.54 FEET, SOUTH 75'33'09" EAST, 163.02 FEET, SOUTH 64'37'20" EAST, 195.83 FEET, SOUTH 81'24'01" EAST, 185.82 FEET, SOUTH 83'21'55" EAST, 150.78 FEET, NORTH 82'35'47" EAST, 145.75 FEET, NORTH 88'37'02" EAST, 289.27 FEET, NORTH 82'48'31" EAST, 99.43 FEET, SOUTH 72'51'05" EAST, 124.28 FEET, SOUTH 49'04'35" EAST, 589.31 FEET, SOUTH 68'28'09" EAST, 696.95 FEET, SOUTH 83'52'42" EAST, 390.31 FEET, NORTH 79'30'03" EAST, 312.29 FEET, SOUTH 77'09'39" EAST, 405.31 FEET, SOUTH 64"24'04" EAST, 290.41, SOUTH 18"43"07" EAST, 72.17 FEET, SOUTH 32"23"54" WEST, 158.54 FEET, SOUTH 47'59'25" WEST, 306.08 FEET, SOUTH 34'28'28" WEST, 160.69 FEET, SOUTH 22'19'42" WEST, 170.42 FEET, SOUTH 02'47'59" EAST, 173.67 FEET, SOUTH 24'39'51" WEST, 379.39 FEET, SOUTH 20'53'09" WEST, 129.67 FEET, SOUTH 10'47'41" WEST, 262.36 FEET, SOUTH 04'51'48" WEST, 356.75 FEET, SOUTH 06'43'37" WEST, 125.96 FEET, POINT BEING 100.00 FEET EASTERLY OF THE NORTHEAST CORNER OF THE AFORESAID SECTION 22: THENCE RUN NORTH 89'32'11" WEST, 100.00 FEET TO THE NORTHEAST CORNER OF THE AFORESAID SECTION 22; THENCE RUN NORTH 89'32'11" WEST, ALONG THE NORTH LINE OF THE NORTHEAST QUARTER OF SAID SECTION 22, A DISTANCE OF, 1350.44 FEET; THENCE DEPARTING SAID NORTH LINE, RUN SOUTH 40'37'42" WEST, 872.91 FEET TO THE SOUTH LINE OF THE NORTHEAST QUARTER OF THE NORTHWEST QUARTER OF THE NORTHEAST QUARTER OF SAID SECTION 22; THENCE RUN NORTH 89'23'03" WEST, ALONG SAID SOUTH LINE, 73.32 FEET TO THE NORTHEAST CORNER OF THE SOUTHWEST QUARTER OF THE NORTHWEST QUARTER OF THE NORTHEAST QUARTER OF SAID SECTION 22; THENCE RUN SOUTH 01'02'44" WEST, THE EAST LINE OF THE SOUTHWEST QUARTER OF THE NORTHWEST QUARTER OF THE NORTHEAST QUARTER OF SAID SECTION 22, A DISTANCE OF 666.91 FEET TO THE SOUTHEAST CORNER OF SOUTHWEST QUARTER OF THE NORTHWEST QUARTER OF THE NORTHEAST QUARTER OF SAID SECTION 22; THENCE RUN NORTH 89'13'56" WEST ALONG THE SOUTH LINE OF SOUTHWEST QUARTER OF THE NORTHWEST QUARTER OF THE NORTHEAST QUARTER OF SAID SECTION 22, A DISTANCE OF 47.47 FEET; THENCE RUN SOUTH 31'25'16" WEST, 1.75 FEET; THENCE RUN SOUTH 62'36'34" WEST, 98.66'; THENCE RUN SOUTH 34'07'05" WEST, 113.15 FEET; THENCE RUN SOUTH 67:31'03" WEST, 41.43 FEET; THENCE RUN SOUTH 72'42'59" WEST, 159.42; THENCE RUN SOUTH 65'14'08" WEST, 143.37 FEET; THENCE RUN SOUTH 76'24'55" WEST, 72.29 FEET TO A POINT ON THE AFORESAID EAST RIGHT-OF-WAY OF COUNTY ROAD 48, SAID POINT IS LYING ON A NON-TANGENT CURVE CONCAVE NORTHWESTERLY; THENCE RUN NORTHWESTERLY ALONG SAID NON-TANGENT CURVE HAVING A RADIUS OF 5679.57 FEET, A CENTRAL ANGLE OF 03'34'40", AN ARC LENGTH OF 354.66 FEET, A CHORD LENGTH OF 354.60 FEET, AND A CHORD BEARING OF NORTH 24'58'35" WEST TO A POINT; THENCE RUN NORTH 23'24'43" WEST, NON-TANGENT TO SAID CURVE, 1423.66 FEET TO THE POINT OF BEGINNING.

> Sen Zhang ISSUING OFFICER

NORTH LAKE COUNTY WATER & SEWER COMPANY, LLC WASTEWATER TARIFF

ORIGINAL SHEET NO. 4.0

COMMUNITIES SERVED LISTING

County <u>Name</u>	Development <u>Name</u>	Rate Schedule <u>Available</u>	Sheet No.	
Lake	The Falls at Drake's Point	GS & RS	12 & 13	

TECHNICAL TERMS AND ABBREVIATIONS

- 1.0 "BFC" The abbreviation for "Base Facility Charge" which is the minimum amount the Company may charge its Customers and is separate from the amount the Company bills its Customers for wastewater consumption.
- 2.0 <u>"CERTIFICATE"</u> A document issued by the Commission authorizing the Company to provide wastewater service in a specific territory.
- 3.0 "COMMISSION" The shortened name for the Florida Public Service Commission.
- 4.0 <u>"COMMUNITIES SERVED"</u> The group of Customers who receive wastewater service from the Company and whose service location is within a specific area or locality that is uniquely separate from another.
- 5.0 "COMPANY" The shortened name for the full name of the utility which is NORTH LAKE COUNTY WATER & SEWER COMPANY, LLC
- 6.0 "CUSTOMER" Any person, firm or corporation who has entered into an agreement to receive wastewater service from the Company and who is liable for the payment of that wastewater service.
- 7.0 "CUSTOMER'S INSTALLATION" All pipes, shut-offs, valves, fixtures and appliances or apparatus of every kind and nature used in connection with or forming a part of the installation for rendering wastewater service to the Customer's side of the Service Connection whether such installation is owned by the Customer or used by the Customer under lease or other agreement.
- 8.0 "MAIN" A pipe, conduit, or other facility used to convey wastewater service to individual service lines or through other mains.
- 9.0 <u>"RATE"</u> Amount which the Company may charge for wastewater service which is applied to the Customer=s actual consumption.
- 10.0 <u>"RATE SCHEDULE"</u> The rate(s) or charge(s) for a particular classification of service plus the several provisions necessary for billing, including all special terms and conditions under which service shall be furnished at such rate or charge.
- 11.0 <u>"SERVICE"</u> As mentioned in this tariff and in agreement with Customers, AService@ shall be construed to include, in addition to all wastewater service required by the Customer, the readiness and ability on the part of the Company to furnish wastewater service to the Customer. Service shall conform to the standards set forth in Section 367.111 of the Florida Statutes.
- 12.0 <u>"SERVICE CONNECTION"</u> The point where the Company's pipes or meters are connected with the pipes of the Customer.
- 13.0 <u>"SERVICE LINES"</u> The pipes between the Company's Mains and the Service Connection and which includes all of the pipes, fittings and valves necessary to make the connection to the Customer's premises, excluding the meter.
- 14.0 <u>"TERRITORY"</u> The geographical area described, if necessary, by metes and bounds but, in all cases, with township, range and section in a Certificate, which may be within or without the boundaries of an incorporated municipality and may include areas in more than one county.

Sen Zhang ISSUING OFFICER

INDEX OF RULES AND REGULATIONS

	Sheet Number:	Rule <u>Number</u> :
Access to Premises	9.0	12.0
Adjustment of Bills	10.0	20.0
Application	7.0	3.0
Applications by Agents	7.0	4.0
Change of Customer's Installation	8.0	10.0
Continuity of Service	8.0	8.0
Customer Billing	9.0	15.0
Delinquent Bills	9.0	17.0
Evidence of Consumption	10.0	22.0
Extensions	7.0	6.0
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Sen Zhang ISSUING OFFICER

RULES AND REGULATIONS

1.0 <u>GENERAL INFORMATION</u> - These Rules and Regulations are a part of the rate schedules and applications and contracts of the Company and, in the absence of specific written agreement to the contrary, apply without modifications or change to each and every Customer to whom the Company renders wastewater service.

The Company shall provide wastewater service to all Customers requiring such service within its Certificated territory pursuant to Chapter 25-30, Florida Administrative Code and Chapter 367, Florida Statutes.

- 2.0 <u>TARIFF DISPUTE</u> Any dispute between the Company and the Customer or prospective Customer regarding the meaning or application of any provision of this tariff shall be resolved pursuant to Rule 25-22.032, Florida Administrative Code.
- 3.0 <u>APPLICATION</u> In accordance with Rule 25-30.310, Florida Administrative Code, a signed application is required prior to the initiation of service. The Company shall provide each Applicant with a copy of the brochure entitled AYour Water and Wastewater Service,@ prepared by the Florida Public Service Commission.
- 4.0 <u>APPLICATIONS BY AGENTS</u> Applications for wastewater service requested by firms, partnerships, associations, corporations, and others shall be rendered only by duly authorized parties or agents.
- 5.0 <u>REFUSAL OR DISCONTINUANCE OF SERVICE</u> The Company may refuse or discontinue wastewater service rendered under application made by any member or agent of a household, organization, or business in accordance with Rule 25-30.320, Florida Administrative Code.
- 6.0 <u>EXTENSIONS</u> Extensions will be made to the Company's facilities in compliance with Commission Rules and Orders and the Company's tariff.
- 7.0 TYPE AND MAINTENANCE In accordance with Rule 25-30.545, Florida Administrative Code, the Customer's pipes, apparatus and equipment shall be selected, installed, used and maintained in accordance with standard practice and shall conform with the Rules and Regulations of the Company and shall comply with all laws and governmental regulations applicable to same. The Company shall not be responsible for the maintenance and operation of the Customer's pipes and facilities. The Customer expressly agrees not to utilize any appliance or device which is not properly constructed, controlled and protected or which may adversely affect the wastewater service. The Company reserves the right to discontinue or withhold wastewater service to such apparatus or device.

(Continued on Sheet No. 8.0)

(Continued from Sheet No. 7.0)

8.0 <u>CONTINUITY OF SERVICE</u> - In accordance with Rule 25-30.250, Florida Administrative Code, the Company will at all times use reasonable diligence to provide continuous wastewater service and, having used reasonable diligence, shall not be liable to the Customer for failure or interruption of continuous wastewater service.

If at any time the Company shall interrupt or discontinue its service, all Customers affected by said interruption or discontinuance shall be given not less than 24 hours written notice.

9.0 <u>LIMITATION OF USE</u> - Wastewater service purchased from the Company shall be used by the Customer only for the purposes specified in the application for wastewater service. Wastewater service shall be rendered to the Customer for the Customer's own use and the Customer shall not sell or otherwise dispose of such wastewater service supplied by the Company.

In no case shall a Customer, except with the written consent of the Company, extend his lines across a street, alley, lane, court, property line, avenue, or other way in order to furnish wastewater service to the adjacent property through one meter even though such adjacent property may be owned by him. In case of such unauthorized extension, sale, or disposition of service, the Customer's wastewater service will be subject to discontinuance until such unauthorized extension, remetering, sale or disposition of service is discontinued and full payment is made to the Company for wastewater service rendered by the Company (calculated on proper classification and rate schedules) and until reimbursement is made in full to the Company for all extra expenses incurred for clerical work, testing, and inspections. (This shall not be construed as prohibiting a Customer from remetering.)

- 10.0 <u>CHANGE OF CUSTOMER'S INSTALLATION</u> No changes or increases in the Customer's installation, which will materially affect the proper operation of the pipes, mains, or stations of the Company, shall be made without written consent of the Company. The Customer shall be liable for any charge resulting from a violation of this Rule.
- 11.0 <u>INSPECTION OF CUSTOMER'S INSTALLATION</u> All Customer's wastewater service installations or changes shall be inspected upon completion by a competent authority to ensure that the Customer's piping, equipment, and devices have been installed in accordance with accepted standard practice and local laws and governmental regulations. Where municipal or other governmental inspection is required by local rules and ordinances, the Company cannot render wastewater service until such inspection has been made and a formal notice of approval from the inspecting authority has been received by the Company.

Not withstanding the above, the Company reserves the right to inspect the Customer's installation prior to rendering wastewater service, and from time to time thereafter, but assumes no responsibility whatsoever for any portion thereof.

(Continued on Sheet No. 9.0)

(Continued from Sheet No. 8.0)

- 12.0 <u>ACCESS TO PREMISES</u> In accordance with Rule 25-30.320(2)(f), Florida Administrative Code, the Customer shall provide the duly authorized agents of the Company access at all reasonable hours to its property. If reasonable access is not provided, service may be discontinued pursuant to the above rule.
- 13.0 PROTECTION OF COMPANY'S PROPERTY The Customer shall exercise reasonable diligence to protect the Company's property. If the Customer is found to have tampered with any Company property or refuses to correct any problems reported by the Company, service may be discontinued in accordance with Rule 25-30.320, Florida Administrative Code. In the event of any loss or damage to property of the Company caused by or arising out of carelessness, neglect, or misuse by the Customer, the cost of making good such loss or repairing such damage shall be paid by the Customer.
- 14.0 <u>RIGHT-OF-WAY OR EASEMENTS</u> The Customer shall grant or cause to be granted to the Company, and without cost to the Company, all rights, easements, permits, and privileges which are necessary for the rendering of wastewater service.
- 15.0 <u>CUSTOMER BILLING</u> Bills for wastewater service will be rendered Monthly, Bimonthly, or Quarterly as stated in the rate schedule.

In accordance with Rule 25-30.335, Florida Administrative Code, the Company may not consider a Customer delinquent in paying his or her bill until the twenty-first day after the Company has mailed or presented the bill for payment.

A municipal or county franchise tax levied upon a water or wastewater public Company shall not be incorporated into the rate for water or wastewater service but shall be shown as a separate item on the Company's bills to its Customers in such municipality or county.

If a Company utilizes the base facility and usage charge rate structure and does not have a Commission authorized vacation rate, the Company shall bill the Customer the base facility charge regardless of whether there is any usage.

- 16.0 PAYMENT OF WATER AND WASTEWATER SERVICE BILLS CONCURRENTLY In accordance with Rule 25-30.320(2)(g), Florida Administrative Code, when both water and wastewater service are provided by the Company, payment of any wastewater service bill rendered by the Company to a Customer shall not be accepted by the Company without the simultaneous or concurrent payment of any water service bill rendered by the Company.
- 17.0 <u>DELINQUENT BILLS</u> When it has been determined that a Customer is delinquent in paying any bill, wastewater service may be discontinued after the Company has mailed or presented a written notice to the Customer in accordance with Rule 25-30.320, Florida Administrative Code.

(Continued on Sheet No. 10.0)

(Continued from Sheet No. 9.0)

- 18.0 <u>TERMINATION OF SERVICE</u> When a Customer wishes to terminate service on any premises where wastewater service is supplied by the Company, the Company may require reasonable notice to the Company in accordance with Rule 25-30.325, Florida Administrative Code.
- 19.0 <u>UNAUTHORIZED CONNECTIONS</u> <u>WASTEWATER</u> Any unauthorized connections to the Customer's wastewater service shall be subject to immediate discontinuance without notice, in accordance with Rule 25-30.320, Florida Administrative Code.
- 20.0 <u>ADJUSTMENT OF BILLS</u> When a Customer has been undercharged as a result of incorrect application of the rate schedule, incorrect reading of the meter, incorrect connection of the meter, or other similar reasons, the amount may be refunded or billed to the Customer as the case may be pursuant to Rules 25-30.340 and 25-30.350, Florida Administrative Code.
- 21.0 <u>FILING OF CONTRACTS</u> Whenever a Developer Agreement or Contract, Guaranteed Revenue Contract, or Special Contract or Agreement is entered into by the Company for the sale of its product or services in a manner not specifically covered by its Rules and Regulations or approved Rate Schedules, a copy of such contracts or agreements shall be filed with the Commission prior to its execution in accordance with Rule 25-9.034 and Rule 25-30.550, Florida Administrative Code. If such contracts or agreements are approved by the Commission, a conformed copy shall be placed on file with the Commission within 30 days of execution.
- 22.0 <u>EVIDENCE OF CONSUMPTION</u> The initiation or continuation or resumption of water service to the Customer's premises shall constitute the initiation or continuation or resumption of wastewater service to the Customer's premises regardless of occupancy.

INDEX OF RATES AND CHARGES SCHEDULES

	Sheet Number
Customer Deposits	14.0
General Service, GS	12.0
Miscellaneous Service Charges	15.0
Residential Service, RS	13.0

GENERAL SERVICE

RATE SCHEDULE (GS)

<u>AVAILABILITY</u> - Available throughout the area served by the Company.

<u>APPLICABILITY</u> - For wastewater service to all Customers for which no other schedule applies.

<u>LIMITATIONS</u> - Subject to all of the Rules and Regulations of this Tariff and General Rules and

Regulations of the Commission.

BILLING PERIOD - Monthly

RATE -

Meter Sizes	Base F	acility Charge
5/8" x 3/4"	\$	38.44
3/4"	\$	57.66
1"	\$	96.10
1 1/2"	\$	192.21
2"	\$	307.53
3"	\$	672.73
Charge per 1,000 gallons	\$	5.89

MINIMUM CHARGE - Base Facility Charge

TERMS OF PAYMENT - Bills are due and payable when rendered. In accordance with Rule 25-30.320, Florida

Administrative Code, if a Customer is delinquent in paying the bill for wastewater service,

service may then be discontinued.

<u>TYPE OF FILING</u> - Original Certificate

RESIDENTIAL SERVICE

RATE SCHEDULE (RS)

AVAILABILITY - Available throughout the area served by the Company.

<u>APPLICABILITY</u> - For wastewater service for all purposes in private residences and individually metered

apartment units.

LIMITATIONS - Subject to all of the Rules and Regulations of this Tariff and General Rules and

Regulations of the Commission.

BILLING PERIOD - Monthly

RATE -

Meter Size

All Meter Sizes

\$ 38.44

Charge per 1,000 gallons (10,000 gallon cap)

MINIMUM CHARGE - Base Facility Charge

TERMS OF PAYMENT - Bills are due and payable when rendered. In accordance with Rule 25-30.320, Florida

Administrative Code, if a Customer is delinquent in paying the bill for wastewater service,

service may then be discontinued.

TYPE OF FILING - Original Certificate

General Service

CUSTOMER DEPOSITS

<u>ESTABLISHMENT OF CREDIT</u> - Before rendering wastewater service, the Company may require an Applicant for service to satisfactorily establish credit, but such establishment of credit shall not relieve the Customer from complying with the Company's rules for prompt payment. Credit will be deemed so established if the Customer complies with the requirements of Rule 25-30.311, Florida Administrative Code.

AMOUNT OF DEPOSIT - The amount of initial deposit shall be the following according to meter size:

5/8" x 3/4"	\$152.00	2x average monthly bill
All others meter sizes	2x average monthly bill	2x average monthly bill

Residential Service

<u>ADDITIONAL DEPOSIT</u> - Under Rule 25-30.311(7), Florida Administrative Code, the Company may require a new deposit, where previously waived or returned, or an additional deposit in order to secure payment of current bills provided.

<u>INTEREST ON DEPOSIT</u> - The Company shall pay interest on Customer deposits pursuant to Rules 25-30.311(4) and (4a).

<u>REFUND OF DEPOSIT</u> - After a residential Customer has established a satisfactory payment record and has had continuous service for a period of 23 months, the Company shall refund the Customer's deposit provided the Customer has met the requirements of Rule 25-30.311(5), Florida Administrative Code. The Company may hold the deposit of a non-residential Customer after a continuous service period of 23 months and shall pay interest on the non-residential Customer's deposit pursuant to Rules 25-30.311(4) and (5), Florida Administrative Code.

Nothing in this rule shall prohibit the Company from refunding a Customer's deposit in less than 23 months.

EFFECTIVE DATE -	, 2024
TYPE OF FILING -	Original Certificate

MISCELLANEOUS SERVICE CHARGES

The Company may charge the following miscellaneous service charges in accordance with the terms stated herein. If both water and wastewater services are provided, only a single charge is appropriate unless circumstances beyond the control of the Company require multiple actions.

<u>INITIAL CONNECTION</u> - This charge may be levied for service initiation at a location where service did not exist previously.

NORMAL RECONNECTION - This charge may be levied for transfer of service to a new Customer account at a previously served location or reconnection of service subsequent to a Customer requested disconnection.

<u>VIOLATION RECONNECTION</u> - This charge may be levied prior to reconnection of an existing Customer after disconnection of service for cause according to Rule 25-30.320(2), Florida Administrative Code, including a delinquency in bill payment.

<u>PREMISES VISIT CHARGE (IN LIEU OF DISCONNECTION)</u> - This charge may be levied when a service representative visits a premises for the purpose of discontinuing service for nonpayment of a due and collectible bill and does not discontinue service because the Customer pays the service representative or otherwise makes satisfactory arrangements to pay the bill.

<u>LATE PAYMENT CHARGE</u> – This charge may be levied when a customer is delinquent in paying a bill for service, pursuant to Rule 25-30.335(4), F.A.C.

<u>NSF CHARGE</u> – This charge may be levied pursuant to Section 68.065, Florida Statutes, when a customer pays by check and that check is dishonored by the customers banking institution.

Schedule of Miscellaneous Service Charges

	During Regular Business Hours	After Regular Business Hours
Violation Reconnection Charge	\$75.00	\$100.00
Premises Visit Charge	\$75.00	N/A
Late Payment Charge	\$ 10.00	
Damaging/Tampering/Altering utility system	Actual Cost	Actual Cost
NSF Check Charge	Pursuant to Section 68.065, F.S.	

(Continued on Sheet 15.1)

TYPE OF FILING - Original Certificate

INDEX OF SERVICE AVAILABILITY POLICY AND CHARGES

<u>Description</u>	Sheet Number
Schedule of Charges	18.0
Service Availability Policy	17.0

SERVICE AVAILABILITY POLICY

Developer will install all infrastructure and the developer/customer shall pay the applicable service availability charges set forth on Sheet No.18.0.

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SERVICE AVAILABILITY CHARGES

Plant Capacity Charge	
Per ERC\$	3.000.00

<u>EFFECTIVE DATE</u> - _____, 2024

TYPE OF FILING - Original Certificate

<u>Sen Zhang</u> ISSUING OFFICER

INDEX OF STANDARD FORMS

<u>Description</u>	Sheet No.
APPLICATION FOR WASTEWATER SERVICE	20.0
COPY OF CUSTOMER'S BILL	21.0

APPLICATION FOR WASTWATER SERVICE

NOT APPLICABLE

COPY OF CUSTOMER'S BILL

<u>Sen Zhang</u> ISSUING OFFICER

WATER TARIFF

NORTH LAKE COUNTY WATER & SEWER COMPANY, LLC NAME OF COMPANY

FILED WITH FLORIDA PUBLIC SERVICE COMMISSION

WATER TARIFF

NORTH LAKE COUNTY WATER & SEWER COMPANY, LLC NAME OF COMPANY

8615 Commodity Cir., Suite 17

Orlando, Florida 32819 (ADDRESS OF COMPANY)

(Business & Emergency Telephone Number)

FILED WITH
FLORIDA PUBLIC SERVICE COMMISSION

Sen Zhang ISSUING OFFICER

CHIEF OPERATING OFFICER
TITLE

WATER TARIFF

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Standard Forms	20.0
Technical Terms and Abbreviations	5.0
Territory Authority	3.0

TERRITORY AUTHORITY

CERTIFICATE NUMBER – ____-W

COUNTY -Lake

COMMISSION ORDER(S) APPROVING TERRITORY SERVED -

Order Number <u>Date Issued</u> <u>Docket Number</u> <u>Filing Type</u>

PSC-2024-___-PAA-WS __/__/2024 2024____-WS Original Certificate

DESCRIPTION OF TERRITORY SERVED

A PARCEL OF LAND LYING IN SECTION 15 AND 22, TOWNSHIP 20 SOUTH, RANGE 25 EAST BEING DESCRIBED AS FOLLOWS:

COMMENCE AT NORTH QUARTER CORNER OF SAID SECTION 22 FOR A POINT OF REFERENCE; THENCE RUN NORTH 89"14"57" WEST. 670.22 FEET TO THE EASTERLY RIGHT-OF-WAY LINE OF COUNTY ROAD 48 (F.K.A. STATE ROAD 212) AND THE POINT OF BEGINNING; THENCE RUN THE FOLLOWING 4 COURSES ALONG SAID EASTERLY RIGHT-OF-WAY LINE, NORTH 23'24'43" WEST, 1531.02 FEET; THENCE RUN SOUTH 66'37'55" WEST, 16.97 FEET; THENCE NORTH 2018'28" WEST, 226.54 FEET; DEPARTING SAID EAST RIGHT-OF-WAY LINE RUN THENCE THE RUN NORTH 20'00'00" WEST, 317.00 FEET; NORTH 20'34'23" WEST, 201.94 FEET; THENCE THENCE RUN NORTH 19'50'21" WEST, NORTH 69'59'13" EAST, 405.58 FEET; THENCE RUN 210.05 THENCE RUN SOUTH 19'51'32" EAST, 406.34 FEET; THENCE RUN NORTH 70'07'30" EAST, 622.19 FEET; THENCE RUN NORTH 02'08'18" EAST, 961.62 FEET TO A POINT ON THE 62.5 FOOT CONTOUR LINE, BEING THE FLORIDA DEPARTMENT OF ENVIRONMENTAL PROTECTION "SAFE UPLAND" LINE OF THE WATERS OF LAKE HARRIS, THENCE RUN ALONG SAID SAFE UPLAND" LINE CONTOUR BEING APPROXIMATED BY THE FOLLOWING COURSES: SOUTH 48'13'31" EAST, 171.61" FEET, SOUTH 30'28'21" EAST, 198.50 FEET, SOUTH 89'28'36" EAST, 214.54 FEET, SOUTH 75'33'09" EAST, 163.02 FEET, SOUTH 64'37'20" EAST, 195.83 FEET, SOUTH 81'24'01" EAST, 185.82 FEET, SOUTH 83'21'55" EAST, 150.78 FEET, NORTH 82'35'47" EAST, 145.75 FEET, NORTH 88'37'02" EAST, 289.27 FEET, NORTH 82'48'31" EAST, 99.43 FEET, SOUTH 72'51'05" EAST, 124.28 FEET, SOUTH 49'04'35" EAST, 589.31 FEET, SOUTH 68'28'09" EAST, 696.95 FEET, SOUTH 83'52'42" EAST, 390.31 FEET, NORTH 79'30'03" EAST, 312.29 FEET, SOUTH 77'09'39" EAST, 405.31 FEET, 158.54 FEET. SOUTH 64'24'04" EAST, 290.41, SOUTH 18'43'07" EAST, 72.17 FEET, SOUTH 32'23'54" WEST, SOUTH 47'59'25" WEST, 306.08 FEET, SOUTH 34'28'28" WEST, 160.69 FEET, SOUTH 22'19'42" WEST, 170.42 FEET, SOUTH 02'47'59" EAST, 173.67 FEET, SOUTH 24'39'51" WEST, 379.39 FEET, SOUTH 20'53'09" WEST, 129.67 FEET, SOUTH 10'47'41" WEST, 262.36 FEET, SOUTH 04'51'48" WEST, 356.75 FEET, SOUTH 06'43'37" WEST, 125.96 FEET, POINT BEING 100.00 FEET EASTERLY OF THE NORTHEAST CORNER OF THE AFORESAID SECTION 22: THENCE RUN

NORTH 89'32'11" WEST, 100.00 FEET TO THE NORTHEAST CORNER OF THE AFORESAID SECTION 22; THENCE RUN NORTH 89'32'11" WEST, ALONG THE NORTH LINE OF THE NORTHEAST QUARTER OF SAID SECTION 22, A DISTANCE OF, 1350.44 FEET; THENCE DEPARTING SAID NORTH LINE, RUN SOUTH 40'37'42" WEST, 872.91 FEET TO THE SOUTH LINE OF THE NORTHEAST QUARTER OF THE NORTHWEST QUARTER OF THE NORTHEAST QUARTER OF SAID SECTION 22; THENCE RUN NORTH 89'23'03" WEST, ALONG SAID SOUTH LINE, 73.32 FEET TO THE NORTHEAST CORNER OF THE SOUTHWEST QUARTER OF THE NORTHWEST QUARTER OF THE NORTHEAST QUARTER OF SAID SECTION 22; THENCE RUN SOUTH 01'02'44" WEST, THE EAST LINE OF THE SOUTHWEST QUARTER OF THE NORTHWEST QUARTER OF THE NORTHEAST QUARTER OF SAID SECTION 22, A DISTANCE OF 666.91 FEET TO THE SOUTHEAST CORNER OF SOUTHWEST QUARTER OF THE NORTHWEST QUARTER OF THE NORTHEAST QUARTER OF SAID SECTION 22: THENCE RUN NORTH 89"13"56" WEST ALONG THE SOUTH LINE OF SOUTHWEST QUARTER OF THE NORTHWEST QUARTER OF THE NORTHEAST QUARTER OF SAID SECTION 22, A DISTANCE OF 47.47 FEET; THENCE RUN SOUTH 31'25'16" WEST, 1.75 FEET; THENCE RUN SOUTH 62'36'34" WEST, 98.66'; THENCE RUN SOUTH 34'07'05" WEST, 113.15 FEET; THENCE RUN SOUTH 67'31'03" WEST, 41.43 FEET; THENCE RUN SOUTH 72'42'59" WEST, 159.42; THENCE RUN SOUTH 65'14'08" WEST, 143.37 FEET; THENCE RUN SOUTH 76'24'55" WEST, 72.29 FEET TO A POINT ON THE AFORESAID EAST RIGHT-OF-WAY OF COUNTY ROAD 48, SAID POINT IS LYING ON A NON-TANGENT CURVE CONCAVE NORTHWESTERLY; THENCE RUN NORTHWESTERLY ALONG SAID NON-TANGENT CURVE HAVING A RADIUS OF 5679.57 FEET, A CENTRAL ANGLE OF 03'34'40", AN ARC LENGTH OF 354.66 FEET, A CHORD LENGTH OF 354.60 FEET, AND A CHORD BEARING OF NORTH 24'58'35" WEST TO A POINT; THENCE RUN NORTH 23'24'43" WEST, NON-TANGENT TO SAID CURVE, 1423.66 FEET TO THE POINT OF BEGINNING.

NORTH LAKE COUNTY WATER & SEWER COMPANY, LLC WATER TARIFF

ORIGINAL SHEET NO. 4.0

COMMUNITIES SERVED LISTING

County <u>Name</u> Development Rate Schedule(s)

Name <u>Available</u> Sheets No.

The Falls at Drake Point GS & RS Lake 12.0 & 13.0

TECHNICAL TERMS AND ABBREVIATIONS

- 1.0 <u>"BFC"</u> The abbreviation for "Base Facility Charge" which is the minimum amount the Company may charge its Customers and is separate from the amount the Company bills its Customers for water consumption.
- 2.0 <u>"CERTIFICATE"</u> A document issued by the Commission authorizing the Company to provide water service in a specific territory.
- 3.0 "COMMISSION" The shortened name for the Florida Public Service Commission.
- 4.0 <u>"COMMUNITIES SERVED"</u> The group of Customers who receive water service from the Company and whose service location is within a specific area or locality that is uniquely separate from another.
- 5.0 "COMPANY" The shortened name for the full name of the utility which is NORTH LAKE COUNTY WATER & SEWER COMPANY, LLC
- 6.0 <u>"CUSTOMER"</u> Any person, firm or corporation who has entered into an agreement to receive water service from the Company and who is liable for the payment of that water service.
- 7.0 "CUSTOMER'S INSTALLATION" All pipes, shut-offs, valves, fixtures and appliances or apparatus of every kind and nature used in connection with or forming a part of the installation for rendering water service to the Customer's side of the Service Connection whether such installation is owned by the Customer or used by the Customer under lease or other agreement.
- 8.0 "MAIN" A pipe, conduit, or other facility used to convey water service to individual service lines or through other mains.
- 9.0 <u>"RATE"</u> Amount which the Company may charge for water service which is applied to the Customer's actual consumption.
- 10.0 <u>"RATE SCHEDULE"</u> The rate(s) or charge(s) for a particular classification of service plus the several provisions necessary for billing, including all special terms and conditions under which service shall be furnished at such rate or charge.
- 11.0 <u>"SERVICE"</u> As mentioned in this tariff and in agreement with Customers, "Service" shall be construed to include, in addition to all water service required by the Customer, the readiness and ability on the part of the Company to furnish water service to the Customer. Service shall conform to the standards set forth in Section 367.111 of the Florida Statutes.
- 12.0 <u>"SERVICE CONNECTION"</u> The point where the Company's pipes or meters are connected with the pipes of the Customer.
- 13.0 <u>"SERVICE LINES"</u> The pipes between the Company's Mains and the Service Connection and which includes all of the pipes, fittings and valves necessary to make the connection to the Customer's premises, excluding the meter.
- 14.0 <u>"TERRITORY"</u> The geographical area described, if necessary, by metes and bounds but, in all cases, with township, range and section in a Certificate, which may be within or without the boundaries of an incorporated municipality and may include areas in more than one county.

INDEX OF RULES AND REGULATIONS

	Sheet <u>Number</u>	Rule <u>Number</u>
Access to Premises	9.0	14.0
Adjustment of Bills	10.0	22.0
Adjustment of Bills for Meter Error	10.0	23.0
All Water Through Meter	10.0	21.0
Application	7.0	3.0
Applications by Agents	7.0	4.0
Change of Customer's Installation	8.0	11.0
Continuity of Service	8.0	9.0
Customer Billing	9.0	16.0
Delinquent Bills	7.0	8.0
Extensions	7.0	6.0
Filing of Contracts	10.0	25.0
General Information	7.0	1.0
Inspection of Customer's Installation	9.0	13.0
Limitation of Use	8.0	10.0
Meter Accuracy Requirements	10.0	24.0
Meters	10.0	20.0
Payment of Water and Wastewater Service Bills Concurrently	10.0	18.0
Protection of Company's Property	8.0	12.0
Refusal or Discontinuance of Service	7.0	5.0
Right-of-way or Easements	9.0	15.0
Tariff Dispute	7.0	2.0
Termination of Service	9.0	17.0
Type and Maintenance	7.0	7.0
Unauthorized Connections – Water	10.0	19.0

Sen Zhang ISSUING OFFICER

CHIEF OPERATING OFFICER TITLE

RULES AND REGULATIONS

- 1.0 <u>GENERAL INFORMATION</u> These Rules and Regulations are a part of the rate schedules and applications and contracts of the Company and, in the absence of specific written agreement to the contrary, apply without modifications or change to each and every Customer to whom the Company renders water service.
 - The Company shall provide water service to all Customers requiring such service within its Certificated territory pursuant to Chapter 25-30, Florida Administrative Code and Chapter 367, Florida Statutes.
- 2.0 <u>TARIFF DISPUTE</u> Any dispute between the Company and the Customer or prospective Customer regarding the meaning or application of any provision of this tariff shall be resolved pursuant to Rule 25-22.032, Florida Administrative Code.
- 3.0 <u>APPLICATION</u> In accordance with Rule 25-30.310, Florida Administrative Code, a signed application is required prior to the initiation of service. The Company shall provide each Applicant with a copy of the brochure entitled "Your Water and Wastewater Service," prepared by the Florida Public Service Commission.
- 4.0 <u>APPLICATIONS BY AGENTS</u> Applications for water service requested by firms, partnerships, associations, corporations, and others shall be rendered only by duly authorized parties or agents.
- 5.0 <u>REFUSAL OR DISCONTINUANCE OF SERVICE</u> The Company may refuse or discontinue water service rendered under application made by any member or agent of a household, organization, or business in accordance with Rule 25-30.320, Florida Administrative Code.
- 6.0 <u>EXTENSIONS</u> Extensions will be made to the Company's facilities in compliance with Commission Rules and Orders and the Company's tariff.
- 7.0 <u>TYPE AND MAINTENANCE</u> In accordance with Rule 25-30.545, Florida Administrative Code, the Customer's pipes, apparatus and equipment shall be selected, installed, used and maintained in accordance with standard practice and shall conform with the Rules and Regulations of the Company and shall comply with all laws and governmental regulations applicable to same. The Company shall not be responsible for the maintenance and operation of the Customer's pipes and facilities. The Customer expressly agrees not to utilize any appliance or device which is not properly constructed, controlled and protected or which may adversely affect the water service. The Company reserves the right to discontinue or withhold water service to such apparatus or device.
- 8.0 <u>DELINQUENT BILLS</u> When it has been determined that a Customer is delinquent in paying any bill, water service may be discontinued after the Company has mailed or presented a written notice to the Customer in accordance with Rule 25-30.320, Florida Administrative Code.

(Continued on Sheet No. 8.0)

(Continued from Sheet No. 7.0)

9.0 <u>CONTINUITY OF SERVICE</u> - In accordance with Rule 25-30.250, Florida Administrative Code, the Company will at all times use reasonable diligence to provide continuous water service and, having used reasonable diligence, shall not be liable to the Customer for failure or interruption of continuous water service.

If at any time the Company shall interrupt or discontinue its service, all Customers affected by said interruption or discontinuance shall be given not less than 24 hours written notice.

10.0 <u>LIMITATION OF USE</u> - Water service purchased from the Company shall be used by the Customer only for the purposes specified in the application for water service. Water service shall be rendered to the Customer for the Customer's own use and the Customer shall not sell or otherwise dispose of such water service supplied by the Company.

In no case shall a Customer, except with the written consent of the Company, extend his lines across a street, alley, lane, court, property line, avenue, or other way in order to furnish water service to the adjacent property through one meter even though such adjacent property may be owned by him. In case of such unauthorized extension, sale, or disposition of service, the Customer's water service will be subject to discontinuance until such unauthorized extension, remetering, sale or disposition of service is discontinued and full payment is made to the Company for water service rendered by the Company (calculated on proper classification and rate schedules) and until reimbursement is made in full to the Company for all extra expenses incurred for clerical work, testing, and inspections. (This shall not be construed as prohibiting a Customer from remetering.)

- 11.0 <u>CHANGE OF CUSTOMER'S INSTALLATION</u> No changes or increases in the Customer's installation, which will materially affect the proper operation of the pipes, mains, or stations of the Company, shall be made without written consent of the Company. The Customer shall be liable for any charge resulting from a violation of this Rule.
- 12.0 <u>PROTECTION OF COMPANY'S PROPERTY</u> The Customer shall exercise reasonable diligence to protect the Company's property. If the Customer is found to have tampered with any Company property or refuses to correct any problems reported by the Company, service may be discontinued in accordance with Rule 25-30.320. Florida Administrative Code.

In the event of any loss or damage to property of the Company caused by or arising out of carelessness, neglect, or misuse by the Customer, the cost of making good such loss or repairing such damage shall be paid by the Customer.

(Continued on Sheet No. 9.0)

(Continued from Sheet No. 8.0)

- 13.0 <u>INSPECTION OF CUSTOMER'S INSTALLATION</u> All Customer's water service installations or changes shall be inspected upon completion by a competent authority to ensure that the Customer's piping, equipment, and devices have been installed in accordance with accepted standard practice and local laws and governmental regulations. Where municipal or other governmental inspection is required by local rules and ordinances, the Company cannot render water service until such inspection has been made and a formal notice of approval from the inspecting authority has been received by the Company.
 - Not withstanding the above, the Company reserves the right to inspect the Customer's installation prior to rendering water service, and from time to time thereafter, but assumes no responsibility whatsoever for any portion thereof.
- 14.0 <u>ACCESS TO PREMISES</u> In accordance with Rule 25-30.320(2)(f), Florida Administrative Code, the Customer shall provide the duly authorized agents of the Company access at all reasonable hours to its property. If reasonable access is not provided, service may be discontinued pursuant to the above rule.
- 15.0 <u>RIGHT-OF-WAY OR EASEMENTS</u> The Customer shall grant or cause to be granted to the Company, and without cost to the Company, all rights, easements, permits, and privileges which are necessary for the rendering of water service.
- 16.0 <u>CUSTOMER BILLING</u> Bills for water service will be rendered Monthly, Bimonthly, or Quarterly as stated in the rate schedule.

In accordance with Rule 25-30.335, Florida Administrative Code, the Company may not consider a Customer delinquent in paying his or her bill until the twenty-first day after the Company has mailed or presented the bill for payment.

A municipal or county franchise tax levied upon a water or wastewater public Company shall not be incorporated into the rate for water or wastewater service but shall be shown as a separate item on the Company's bills to its Customers in such municipality or county.

If a Company utilizes the base facility and usage charge rate structure and does not have a Commission authorized vacation rate, the Company shall bill the Customer the base facility charge regardless of whether there is any usage.

17.0 <u>TERMINATION OF SERVICE</u> - When a Customer wishes to terminate service on any premises where water service is supplied by the Company, the Company may require reasonable notice to the Company in accordance with Rule 25-30.325, Florida Administrative Code.

(Continued on Sheet No. 10.0)

(Continued from Sheet No. 9.0)

- 18.0 PAYMENT OF WATER AND WASTEWATER SERVICE BILLS CONCURRENTLY In accordance with Rule 25-30.320(2)(g), Florida Administrative Code, when both water and wastewater service are provided by the Company, payment of any water service bill rendered by the Company to a Customer shall not be accepted by the Company without the simultaneous or concurrent payment of any wastewater service bill rendered by the Company.
- 19.0 <u>UNAUTHORIZED CONNECTIONS WATER</u> Any unauthorized connections to the Customer's water service shall be subject to immediate discontinuance without notice, in accordance with Rule 25-30.320, Florida Administrative Code.
- 20.0 <u>METERS</u> All water meters shall be furnished by and remain the property of the Company and shall be accessible and subject to its control, in accordance with Rule 25-30.230, Florida Administrative Code.
- 21.0 <u>ALL WATER THROUGH METER</u> That portion of the Customer's installation for water service shall be so arranged to ensure that all water service shall pass through the meter. No temporary pipes, nipples or spaces are permitted and under no circumstances are connections allowed which may permit water to bypass the meter or metering equipment.
- 22.0 <u>ADJUSTMENT OF BILLS</u> When a Customer has been undercharged as a result of incorrect application of the rate schedule, incorrect reading of the meter, incorrect connection of the meter, or other similar reasons, the amount may be refunded or billed to the Customer as the case may be pursuant to Rules 25-30.340 and 25-30.350, Florida Administrative Code.
- 23.0 <u>ADJUSTMENT OF BILLS FOR METER ERROR</u> When meter tests are made by the Commission or by the Company, the accuracy of registration of the meter and its performance shall conform with Rule 25-30.262, Florida Administrative Code and any adjustment of a bill due to a meter found to be in error as a result of any meter test performed whether for unauthorized use or for a meter found to be fast, slow, non-registering, or partially registering, shall conform with Rule 25-30.340, Florida Administrative Code.
- 24.0 <u>METER ACCURACY REQUIREMENTS</u> All meters used by the Company should conform to the provisions of Rule 25-30.262, Florida Administrative Code.
- 25.0 <u>FILING OF CONTRACTS</u> Whenever a Developer Agreement or Contract, Guaranteed Revenue Contract, or Special Contract or Agreement is entered into by the Company for the sale of its product or services in a manner not specifically covered by its Rules and Regulations or approved Rate Schedules, a copy of such contracts or agreements shall be filed with the Commission prior to its execution in accordance with Rule 25-9.034 and Rule 25-30.550, Florida Administrative Code. If such contracts or agreements are approved by the Commission, a conformed copy shall be placed on file with the Commission within 30 days of execution.

INDEX OF RATES AND CHARGES SCHEDULES

	Sheet Number
Customer Deposits	14.0
General Service, GS	12.0
Meter Test Deposit	15.0
Miscellaneous Service Charges	16.0
Residential Service, RS	13.0

GENERAL SERVICE

RATE SCHEDULE (GS)

<u>AVAILABILITY</u> - Available throughout the area served by the Company.

<u>APPLICABILITY</u> - For water service to all Customers for which no other schedule applies.

<u>LIMITATIONS</u> - Subject to all of the Rules and Regulations of this Tariff and General Rules and

Regulations of the Commission.

BILLING PERIOD – Monthly

RATE -

Meter Sizes	Base Facility Charge	
5/8" x 3/4" 3/4" 1" 1 1/2" 2" 3"	\$ \$ \$ \$ \$ \$	43.82 65.73 109.55 219.10 350.56 766.85
Charge per 1,000 gallons	\$	4.77

MINIMUM CHARGE – Base Facility Charge

TERMS OF PAYMENT – Bills are due and payable when rendered. In accordance with Rule 25-30.320, Florida

Administrative Code, if a Customer is delinquent in paying the bill for water service,

service may then be discontinued.

TYPE OF FILING – Original Certificate

RESIDENTIAL SERVICE

RATE SCHEDULE (RS)

AVAILABILITY –	Available throughout the area served by the Company.		
APPLICABILITY -	For water service for all purposes in private residences and individually metered apartment units.		
<u>LIMITATIONS</u> –	Subject to all of the Rules and Regulations of this Tariff and General Rules and Regulations of the Commission.		
BILLING PERIOD -	Monthly		
RATE –	Meter Sizes All Meter Sizes Charge per 1,000 gallons 0 – 7,000 gallons Over 7,000 gallons	Base Faci	43.82 4.59 5.74
MINIMUM CHARGE – TERMS OF PAYMENT –	Base Facility Charge Bills are due and payable when rendered. In acc Administrative Code, if a Customer is delinquer		

service may then be discontinued.

EFFECTIVE DATE -	, 2024
TYPE OF FILING -	Original Certificate

CUSTOMER DEPOSITS

<u>ESTABLISHMENT OF CREDIT</u> - Before rendering water service, the Company may require an Applicant for service to satisfactorily establish credit, but such establishment of credit shall not relieve the Customer from complying with the Company's rules for prompt payment. Credit will be deemed so established if the Customer complies with the requirements of Rule 25-30.311, Florida Administrative Code.

AMOUNT OF DEPOSIT - The amount of initial deposit shall be the following according to meter size:

	Residential Service	General Service
5/8" x 3/4" All others meter sizes	\$175.00 2x average monthly bill	2x average monthly bill 2x average monthly bill

<u>ADDITIONAL DEPOSIT</u> - Under Rule 25-30.311(7), Florida Administrative Code, the Company may require a new deposit, where previously waived or returned, or an additional deposit in order to secure payment of current bills provided.

<u>INTEREST ON DEPOSIT</u> - The Company shall pay interest on Customer deposits pursuant to Rules 25-30.311(4) and (4a).

<u>REFUND OF DEPOSIT</u> - After a residential Customer has established a satisfactory payment record and has had continuous service for a period of 23 months, the Company shall refund the Customer's deposit provided the Customer has met the requirements of Rule 25-30.311(5), Florida Administrative Code. The Company may hold the deposit of a non-residential Customer after a continuous service period of 23 months and shall pay interest on the non-residential Customer's deposit pursuant to Rules 25-30.311(4) and (5), Florida Administrative Code.

Nothing in this rule shall prohibit the Company from refunding a Customer's deposit in less than 23 months.

EFFECTIVE DATE –	, 2024
TYPE OF FILING -	Original Certificate

TEMPORARY METER DEPOSIT

This deposit would be collected from commercial entities requesting a temporary meter for construction activities to defray the costs of installing and removing facilities. Once temporary meter service is terminated, the Utility will credit the customer with the reasonable salvage value of the service facilities and materials consistent with Rules 25-30.315 and 25-30.345, F.A.C.

AMOUNT	OF	DEPOSIT	

i emporary ivieter Deposit	Temporary Meter Deposit	
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Actual Cost

EFFECTIVE DATE -	, 2024
TYPE OF FILING -	Original Certificate

METER TEST DEPOSIT

METER BENCH TEST REQUEST - If any Customer requests a bench test of his or her water meter, in accordance with Rule 25-30.266, Florida Administrative Code, the Company may require a deposit to defray the cost of testing; such deposit shall not exceed the schedule of fees found in Rule 25-30.266, Florida Administrative Code.

METER SIZE	<u>FEE</u>
5/8" x 3/4"	\$20.00
1" and 1 1/2"	\$25.00
2" and over	Actual Cost

<u>REFUND OF METER BENCH TEST DEPOSIT</u> - The Company may refund the meter bench test deposit in accordance with Rule 25-30.266, Florida Administrative Code.

<u>METER FIELD TEST REQUEST</u> - A Customer may request a no-charge field test of the accuracy of a meter in accordance with Rule 25-30.266, Florida Administrative Code.

MISCELLANEOUS SERVICE CHARGES

The Company may charge the following miscellaneous service charges in accordance with the terms stated herein. If both water and wastewater services are provided, only a single charge is appropriate unless circumstances beyond the control of the Company require multiple actions.

<u>INITIAL CONNECTION</u> - This charge may be levied for service initiation at a location where service did not exist previously.

<u>NORMAL RECONNECTION</u> - This charge may be levied for transfer of service to a new Customer account at a previously served location or reconnection of service subsequent to a Customer requested disconnection.

<u>VIOLATION RECONNECTION</u> - This charge may be levied prior to reconnection of an existing Customer after disconnection of service for cause according to Rule 25-30.320(2), Florida Administrative Code, including a delinquency in bill payment.

<u>PREMISES VISIT CHARGE (IN LIEU OF DISCONNECTION)</u> - This charge may be levied when a service representative visits a premises for the purpose of discontinuing service for nonpayment of a due and collectible bill and does not discontinue service because the Customer pays the service representative or otherwise makes satisfactory arrangements to pay the bill.

<u>LATE PAYMENT CHARGE</u> – This charge may be levied when a customer is delinquent in paying a bill for service, pursuant to Rule 25-30.335(4), F.A.C.

<u>NSF CHARGE</u> - This charge may be levied pursuant to Section 68.065, Florida Statutes, when a customer pays by check and that check is dishonored by the customers banking institution.

Schedule of Miscellaneous Service Charges

Schedule of Miscellaneous Service Charges

	During Regular Business Hours	After Regular Business Hours
Violation Reconnection Charge	\$75.00	\$100.00
Premises Visit Charge	\$75.00	
Late Payment Charge	\$10.00	
NSF Check Charge	Pursuant to Section 68.065, F.S.	
(Continued on Sheet No. 16.1)		
EFFECTIVE DATE		
TYPE OF FILING – Original Certificate		

(Continued from Sheet No. 16.0)

MISCELLANEOUS SERVICE CHARGES

METER TAMPERING CHARGE - This charge may be levied when an investigation reveals evidence of meter tampering. Pursuant to Rule 25-30.320, F.A.C. whenever service is discontinued for fraudulent use of such service, the utility, before restoring service, may also require the customer to make at his own expense all changes in piping or equipment necessary to eliminate illegal use and to pay an amount reasonably estimated as the deficiency in revenue resulting from such fraudulent use.

BACKFLOW PREVENTION ASSEMBLY CHARGE

This charge applies to general service customers who fail to complete annual backflow prevention assembly testing mandated by the Florida Department of Environmental Protection (FDEP). This charge may be levied after 30 days' notice to the customer and would include an estimate of the amount which will be charged. This noticing period will provide the customer a final opportunity to come into compliance before the Utility performs the necessary testing on the customer's behalf.

Damaging/Tampering/Altering	Meter or	Utility	\$20.00 plus Actual Cost
System Charge:			
Backflow Prevention Ass Testing/Repair/Installation Cha	embly arge:		Actual Cost

TYPE OF FILING – Original Certificate

INDEX OF SERVICE AVAILABILITY POLICY AND CHARGES

Description	Sheet Number
Schedule of Charges	19.0
Service Availability Policy	18.0

SERVICE AVAILABILITY POLICY

Developer will install all infrastructure and the developer/customer shall pay the applicable service availability charges set forth on Sheet No.19.0.

NORTH LAKE COUNTY WATER & SEWER COMPANY, LLC WATER TARIFF

<u>TYPE OF FILING</u> – Original Certificate

ORIGINAL SHEET NO. 19.0

SERVICE AVAILABILITY CHARGES

Plant Capacity Charge Per ERC\$ 2,000.00
Meter Installation Charge Builder will install the water meter as specified by Service Company at builder's expense.
<u>EFFECTIVE DATE</u> –

INDEX OF STANDARD FORMS

<u>Description</u>	Sheet No.
APPLICATION FOR WATER SERVICE	21.0
COPY OF CLISTOMER'S BILL	22 0

APPLICATION FOR WATER SERVICE

N/A

COPY OF CUSTOMER'S BILL